CONSTRUCTION PLANS FOR

# S.L. FONG PARK CITY OF STOCKTON

Call Two Working Days Before You Dia!

1-800-227-2600

# LANDSCAPE ARCHITECT

THE HLA GROUP LANDSCAPE ARCHITECTS & PLANNERS, INC. 1990 THIRD ST. SUITE 500 SACRAMENTO, CA 95814 TEL. (916) 447-7400 FAX (916) 447-8270 CONTACT: BOB HABLITZEL


# ELECTRICAL ENGINEER

HCS ENGINEERING, INC.
4651 QUAIL LAKES DRIVE
STOCKTON, CA 95207
TEL. (209) 478-8270
FAX (209) 478-2169
CONTACT: BHUPENDRA PATEL

# CIVIL ENGINEER

MCR ENGINEERING, INC.
322 SUN WEST PLACE
MANTECA, CA 95337
TEL. (209) 239-6229
FAX. (209) 239-????
CONTACT: VICTOR DUSPIVA

# VICINITY MAP

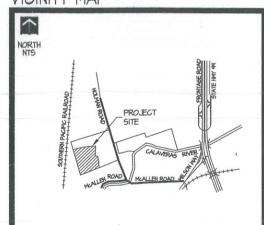







# SHEET INDEX

COVER SHEET CIVIL ENGINEERING NOTES GRADING PLAN GRADING PLAN GRADING PLAN STORM WATER PLAN OVERALL SITE PLAN LAYOUT PLAN LAYOUT PLAN IRRIGATION - OVERALL PLAN IRRIGATION PLAN IRRIGATION PLAN IRRIGATION PLAN PLANTING PLAN PLANTING PLAN PLANTING PLAN
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ELECTRICAL SITE PLAN
PHOTOMETRIC SURVEY ELECTRICAL DETAILS
ELECTRICAL SERVICE DETAILS
STRUCTURAL ENGINEERING PLAN
SHADE STRUCTURE

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LANDSCAPE ARCHITECTS & PLANNE
The RLA Greep, Landscape Architects & Planners.
1990 Their Street Suite 505 Secrements. California S
CELA. 1899 984/447-7400 PAX 984/447.

COV OF 24 SHEETS PROJECT NO.

S.L. FONG PARK PHASE

COVER SHEET

DEPARTMENT OF PUBLIC WORKS CITY OF STOCKTON, CALIFORNIA

1510N 2.	DESCRIPTION	DATE	BY	APPRVI BY	SCALE, NONE	APPROVED BY
					DESIGNED BY:-VPM	( ( 1)
					DRAWN BY, R.B	Glavil OKen
					CHECKED BY: MGE	CITY ENGINEER
					RECORD DWG:	STOCKTON, CA, , V
					DATE: OCTOBER 4TH, 2002	DATE: 11/1/1/2

#### GENERAL NOTES:

- ALL IMPROVEMENTS SHALL BE CONSTRUCTED IN STRUCT ACCORDANCE WITH THE FOLLOWING: CITY OF STOCKTON STANDARD SPECIFICATIONS, AND ALL AMENDMENTS TO DATE, CALIFORNIA DEPARTMENT OF TRANSPORTATION STANDARD SPECIFICATIONS (CALIFORNS) (LATEST EDITION), WHERE APPLICABLE. ALL WORK SHALL BE UNDER THE INSPECTION OF THE RESPECTIVE ENTITY.
- THE INSPECTION OF THE RESPECTIVE ENTITY.

  IT IS INTENDED THAT THESE PLANS AND SPECIFICATIONS REQUIRE ALL LABOR AND MATERIALS NECESSARY AND PROPER FOR THE WORK CONTEMPLATED AND THAT THE WORK BE COMPLETED IN ACCORDANCE WITH THEIR TRUE INTENT AND PURPOSE. THE CONTRACTOR SHALL NOTIFY THE ENGINEER IMMEDIATELY REGARDING PACHICATIONS. DESCRIPE PORTIONS OF THE PUAN'S AND SPECIFICATIONS. IS CORREP PORTIONS OF THE WORK IN GENERAL FERMS BUT NOT IN COMPLETE DETAIL, IT IS UNDERSTOOD THAT ONLY THE BEST GENERAL PRACTICE IS TO PREVAIL AND THAT ONLY MATERIALS AND WORKMANSHIP OF THE FIRST QUALITY ARE TO BE USED.
- CONSTRUCTION STAKING FOR GRADING, CURB, GUTTER, SIDEWALK, SANITARY SEWER, STORM DRAIN AND WATER SHALL BE DONE UNDER THE DIRECTION OF M.C.R. ENGINEERING. THE CONTRACTOR SHALL NOTHLY THE ENGINEER SEVENT-Y-WO (72) HOURS IN ADVANCE OF THIS NEED FOR STAKING. ANY STAKING REQUESTED BY THE CONTRACTOR OF HIS SUB-CONTRACTORS THAT IS ABOVE AND BEYORD NORMAL STANDARD SUBDIVISION STAKING NEEDS, WILL BE SUBJECT TO AN EXTRA BACK CHARGE TO THE CONTRACTOR.
- THE CONTRACTOR SHALL EXERCISE DUE CAUTION AND SHALL CAREFULLY PRESERVE BENCH MARKS, REFERENCE POINTS AND ALL SURVEY STAKES, AND SHALL BEAR ALL EXPENSE FOR REPLACEMENT AND/OR ERRORS CAUSED BY THEIR UNINECESSARY LOSS OR DISTURBANCE.
- CONTRACTOR AGREES THAT HE SHALL ASSUME SOLE AND COMPLETE RESPONSIBILITY FOR 108 SITE CONDITIONS DURING THE COURSE OF CONSTRUCTION OF THIS PROJECT, MICLIDING SERTY OF ALL PERSONS AND REPORPETTY, THAT THIS REQUIREMENT SHALL APPLY CONTRIUDUSLY AND NOT BE LIMITED TO NORMAL WORKING HOURS, AND THAT THE CONTRACTOR SHALL DEEPIN, INCENNITY AND HOLD THE OWNER ENGINEER AND THE COTTY HARMLESS FROM ANY AND ALL LIBBUTY, REAL OR ALLEGED, IN CONNECTION WITH THE PERFORMANCE OF WORK ON THIS PROJECT, EXCEPTING FOR LIBBUTY ARRING FROM THE SOLE NEGLIGENCE OF THE OWNER OR THE ENGINEER.
- 6. DELETED
- THE CONTRACTOR SHALL PROVIDE ALL LIGHTS, SIGHS, BARRICADES, FLAGMAN OR OTHER DEVICES NECESSARY FOR PUBLIC SAFETY IN ACCORDANCE WITH THE CURRENT ISSUE OF "MANULA OF TRAFFIC CONTROLS, WARRING SIGHS, LIGHTS AND DEVICES FOR USE IN PERFORMANCE OF WORK UPON HIGHMAY" PUBLISHED BY THE STATE OF GOLFROMM BUSINESS AND TRANSPORTATION AGENCY.
- THE CONTRACTOR SHALL ATTEND A PRE-CONSTRUCTION MEETING WITH THE CITY OF STOCKTON PRIOR TO ISSUANCE OF AN ENCROLHMENT PERMIT AND/OR A CITY OF STOCKTON GRADING AND EROSION CONTROL PERMIT. THE CITY INSPECTOR WILL SCHEDULE THE PRE-CONSTRUCTION MEETING APPROXIMATELY 2 WEEKS AFTER COUNCIL AWARD OF CONTRACT.
- 10. P. G. & E., TELEPHONE AND CABLE TV UNDERGROUND WORK SHALL BE COMPLETED PRIOR TO CONSTRUCTION OF THE CURB, GUTTER, SIDEWALK AND PAYING.
- THE CITY OF STOCKTON OR ASSOCIATED UTILITY COMPANY AND RESIDENCES TO BE AFFECTED SHALL BE NOTHED IMMEDIATELY UPON ANY UTILITY SERVICE DISRUPTION OTHER THAN SPECIFIED ON THESE IMPROVEMENT PLANS AND A 24 HOUR NOTICE SHALL BE GIVEN FOR ANY PLANNED DISRUPTION.
- 12. THE CONTRACTOR SHALL OBTAIN AN ENCROACHMENT PERMIT FROM THE CITY OF STOCKTON, DEPARTMENT OF PUBLIC WORKS OR ANY OTHER APPLICABLE ACEDITIES PRIOR TO COMMENCEMENT OF WORK WITHIN EXISTING OTT PIGHT—OF—MAY. THE CONTRACTOR SHALL BE RESPONSIBLE FOR ALL PERMITS AND LICENSES REQUIRED FOR THE CONSTRUCTION AND COMPLETION OF THE PROJECT.
- 1.3 DELETED
- 14. ASPHALT CONCRETE SHALL BE PLACED ONLY WHEN THE ATMOSPHERIC TEMPERATURE IS ABOVE 50°F.
- CONTRACTOR IS RESPONSIBLE FOR COORDINATION OF THE REMOVAL OR RELOCATION OF ALL EXISTING UTILITIES WITH RESPECTIVE UTILITY COMPANIES.
- 17. DETAIL DRAWING NUMBERS SHOWN ON THE PLANS REFER TO DRAWINGS CONTAINED IN THE CITY OF STOCKTON STANDARD SPECIFICATIONS, THUS: (i.e. DWG. NO.55).
- PRIOR TO COMMENCING ANY WORK, IT SHALL BE THE CONTRACTOR'S RESPONSIBILITY TO HAVE EACH UTILITY COMPANY LOCATE, IN THE FIELD, THEIR MAN AND SERVICE UNES. THE CONTRACTOR'S SHALL NOTIFY WEMBERS OF THE UNDERGROUND SERVICE ALERT (U.S.A.) 48 HOURS IN ADVANCE OF PERFORMING ANY EXCANATION WORK BY CALLING THE TOLL-FREE MANBER (1803) 227-2560. THE CONTRACTOR SHALL RECORD THE U.S.A. ORDER NUMBER AND FURNISH ORDER NUMBER TO OWNER PRIOR TO ANY EXCANATION IT SHALL BE THE CONTRACTOR'S SOLE RESPONSIBILITY TO PROTECT ALL EXISTING UTILITIES SO THAT NO DAMAGE RESULTS TO THEM DURING THE PERFORMANCE OF THIS CONTRACTOR'S SOLE RESAMS TO DAMAGE UTILITIES SHALL BE PAID FOR BY THE CONTRACTOR. THE CONTRACTOR SHALL BE REQUIRED TO COOPERATE WITH OTHER CONTRACTOR. THE CONTRACTOR SHALL BE REQUIRED TO COOPERATE WITH OTHER CONTRACTORS. THE CONTRACTOR SHALL BE REQUIRED TO COOPERATE WITH OTHER CONTRACTORS. THE DEVELOPMENT.
- THE CONTRACTOR SHALL BE RESPONSIBLE FOR PROTECTING EXISTING IMPROVEMENTS FROM DAMAGE. COST OF REPLACING EXISTING IMPROVEMENTS SHALL BE INCLUDED IN THE UNIT PRICE BID FOR ITEMS REQUIRING REMOVAL AND REPLACEMENT OF EXISTING IMPROVEMENTS.
- 20. WHENEVER EXISTING PAVEMENT IS BROKEN OR CUT IN THE INSTALLATION OF THE WORK COVERED BY THESE SPECIFICATIONS, THE PAVEMENT SHALL BE REPLACED, AFTER PROPER BUCKFILLING, WITH PAVEMENT MATERIALS EQUAL TO OR BETTER THAN THE MATERIALS USED IN THE ORIGINAL PAVING. THE FINISHED PAVEMENT SHALL BE SUBJECT TO THE APPROVAL OF THE CITY REPRESENTATIVE.
- PAYMENT FOR REPLACEMENT OF PAVEMENT WHICH IS BROKEN OR CUT DURING THE INSTALLATION OF THE WORK COVERED BY THESE SPECIFICATIONS, SHALL BE THE RESPONSIBILITY OF THE CONTRACTION. NO ADDITIONAL PAYMENT SHALL BE MADE FOR SUCH WORK.
- EXCAVATIONS OF 5 FEET OR MORE IN DEPTH WILL REQUIRE AN EXCAVATION PERMIT FROM THE STATE OF CAUTEONIA DEPARTMENT OF INDUSTRIAL SAFETY. FOR TRENCHES 5 FEET OF MORE IN DEPTH, THE CONTINEATOR SHALL COMPLY WITH SECTION 5-1-02A OF THE CALTRANS STANDARDS, CHAPTER 9 OF THE STATE OF CALIFORNIA LABOR CODE, AND ANY LOCAL CODES OF ROTINANCES.
- 23. WE CALL YOUR ATTENTION TO TITLE B CALIFORNIA ADMINISTRATION CODE SECTION 1540 (A) (1) OF THE CONSTRUCTION SAFETY ORDERS ISSUED BY THE OCCUPATIONAL SAFETY AND HEALTH ASTAINANDES BOARD PURSUANT TO THE CALIFORNIA OCCUPATIONS SAFETY AND HEALTH ACT OF 1973 AS AMENDED WHICH STATES: (1) PHIOR TO OPENING AM EXCANDING REFORM THALL BE MADE TO DETERMINE WHETHER UNDERGROUND INSTALLATIONS; LE. SEWER, WATER, FUEL, ELECTRICAL LINES, ETC., WHILE BE ENCOUNTERED AND ITS OF WHICH SOLVE UNDERGROUND INSTALLATIONS ARE LOCATED, WHICH THE EXCANTION APPROXIMES THE APPROXIMATE LOCATION OF PROBING OR HAND INGOING; AND. WHEN IT IS UNCORED, MEDIATE PROTECTION SHALL BE PROVIDED FOR THE EXISTING INSTALLATION. ALL KNOWN OWNERS OF UNDERGROUND IS ACCURATED. THE ADMINISTRATION SHALL BE PROVIDED FOR THE EXISTING INSTALLATION. ALL KNOWN OWNERS OF UNDERGROUND FACILITIES IN THE AREA CONCERNED SHALL BE ADMISSED OF PROPOSED WORK AT LEAST 48 HOURS PRIOR TO THE START OF ACTUAL EXCANATION.
- 24. ALL TRENCHES ON MAJOR AND COLLECTOR STREETS AND CROSS TRENCHES ON ALL STREETS SHALL BE PAVED WITH TEMPORARY PAVING THE SAME DAY THE PAVEMENT CUT IS MADE.
- APPROPRIATE DUST CONTROL SHALL BE PROVIDED, AT THE CONTRACTOR'S EXPENSE TO MINIMIZE ANY DUST NUISANCE AND SHALL BE IN ACCORDANCE WITH SECTION 10 OF CALTRANS STADLARD SPECIFICATIONS AND THE REQUIREMENTS OF THE CITY OF STOCKTON AND THE APPROVED SWIPPP. SIOCKION AND THE RAPPONDED WIN A PERMIT FROM THE CITY OF STOCKTON MUNICIPAL THE CONTROL SHALL DES OF WATER FROM FIRE HORDANTS FOR CONSTRUCTION PURPOSES THE PERMIT FOR HIS OF WATER THE CITY OF STOCKTON FIRE DEPT.

- THE CONTRACTOR SHALL SUBMIT TO THE ENGINEER, PRIOR TO FINAL ACCEPTANCE, AS-BUILT DRAWNIGS OF ALL IMPROVEMENTS REPRESENTED BY THE PROJECT PLANS AND SPECIFICATIONS.
- 27. AFTER CONSTRUCTION OF ALL IMPROVEMENTS, THE ENGINEER SHALL SUBMIT ONE SET OF REPRODUCIBLE AS—BUILT PLANS. FINAL INVERT ELEVATIONS FOR SEWER AND STORM DORM LIMES THAT ARE TO BE EXTENDED FOR FUTURE CONSTRUCTION SHALL ALSO BE SHOWN ON THE "AS—BUILT" PLANS ALL AS PROVIDED TO THE ENGINEER BY THE CONTRACTOR.
- THE CONTRACTOR SHALL NOTIFY M.C.R. ENGINEERING AT LEAST 48 HOURS PRIOR TO BACKFILING OF ANY PIPE WHICH STUBS TO A FUTURE PHASE OF CONSTRUCTION FOR INVERT VERIFICATION. TOLERANCE SHALL BE IN ACCORDANCE WITH THE CITY OF STOCKTON STANDARD SPECIFICATIONS.
- 30. ANY AND ALL SEDIMENT AND/OR EROSION CONTROL DETAILS CONTAINED WITHIN THESE PLANS ARE TO BE CONSIDERED AS "REFERENCE DETAILS" ONLY AND THE CITY'S APPROVAL OF THESE PLANS AND "REFERENCE DETAILS" DOES NOT RELIEVE THE OWNER/DEVELOPER FROM COMPLANCE WITH THE STORM WATER POLLUTION PREVENTION PLAN (SWPPP) AS APPROVED BY THE CITY'S STORMMATER OWNSHIP.
- IN ADDITION TO ALL OF THE OTHER REQUIRED PERMITS, THE CONTRACTOR SHALL HAVE A GRADING AND EROSION CONTROL PERMIT COMPLETE WITH AN APPROVED SWPPP
- THE CONTRACTOR SHALL COMPLY WITH THE REQUIREMENTS OF THE STATE WATER RESOURCES CONTROL BOARD (SIRRE) ORDER NO. 99-08-0WD, NPDES GENERAL PERMIT NO. ASSOCIODOZ. THE CONTRACTOR SHALL IMPLEMENT AND MONTOR A STORM WATER POLLUTION PREVENTION PLAN (SWPPP) IN ACCORDANCE WITH THE SWRCB REGULATIONS.
- 33. BENCHMARK: #359 FRM 246 IS A SAN JOAQUIN COUNTY BM (BRASS DISK WITH NO DESIGNATION) SET IN NW CORNER OF BRIDGE DECK OF MCALLEN RO. BRIDGE OVER CALAVERAS RIVER LOCATED WESTERLY ALONG MCALLEN 0.46 MI FROM N. WILSON WAY AT THE BEGINNING OF RIVER RD IN NE STOCKTON.
- THE CONTRACTOR SHALL REVIEW SITE PRIOR TO BIDDING. ALL VEGETATION AND DELETERIOUS MATERIALS SHALL BE REMOVED FROM THE SITE AT THE EXPENSE OF THE CONTRACTOR AND SHALL BE INCLUDED IN THE LUMP SUM CLEARING COST.
- THE CONTRACTOR SHALL PRESERVE ALL STAKES AND POINTS SET FOR LINES, GRADES OR MEASUREMENT OF THE WORK IN THEIR PROPER PLACES UNTIL AUTHORIZED TO REMOVE THEM BY THE ENGINEER. ALL EXPENSES INCURRED IN REPLACING STAKES THAT HAVE BEEN REMOVE WITHOUT PROPER AUTHORITY SHALL BE PAID FOR BY THE GENERAL CONTRACTOR.
- 36. A PERMIT SHALL BE OBTAINED FROM THE MUNICIPAL UTILITIES DEPARTMENT FOR CONSTRUCTION WATER FROM A FIRE HYDRANT. THE PERMIT SHALL BE APPROVED BY THE FIRE DEPARTMENT. THE CONTRACTOR SHALL INCLUDE THIS PERMIT AT NO ADDITIONAL COST.

#### STORM DRAIN NOTES:

- ALL STORM DRAIN CONSTRUCTION AND MATERIALS, SHALL BE IN ACCORDANCE WITH THE REQUIREMENTS OF THE CITY OF STOCKTON PUBLIC WORKS DEPARTMENT STANDARD PLANS AND SPECIFICATIONS AND THE APPROVED SWIPP.
- THE CONTRACTOR SHALL PROVIDE ALL LIGHTS, SIGNS, BARRICADES, FLAGMEN OR OTHER DEVICES NECESSARY FOR PUBLIC SAFETY.
- THE CONTRACTOR SHALL PROVIDE ALL SHORING, BRACING, SLOPING OR OTHER PROVISIONS NECESSARY TO PROTECT WORKMEN FOR ALL AREAS TO BE EXCANATED TO A DEPTH OF 5 FEET OR MONE. SAID PROTECTION TO BE DONE IN ACCORDANCE WITH THE REQUIREMENTS OF THE CITY OF STOCKTON DEPARTMENT OF PUBLIC WORKS, AND STATE REGULATIONS.
- 4. DELETED
- THE CONTRACTOR SHALL EXPOSE ALL EXISTING STORM DRAIN PIPES, WHERE A CONNECTION IS TO BE MADE, AND NOTIFY THE ENGINEER IF THERE IS A DISCREPANCY BETWEEN THE SIGNEED PLANS AND THE EXISTING FIELD CONDITION PRIOR TO THE STAR! OF CONSTRUCTION.
- CONTRACTOR TO BE RESPONSIBLE FOR ALL TESTING OF STORM DRAIN FACILITIES IN ACCORDANCE WITH THE CITY OF STOCKTON'S STANDARD SPECIFICATIONS AND PLANS.
- ALL STORM DRAIN LINES SHALL BE CLEANED OF ALL SAND AND DEBRIS PRIOR TO ACCEPTANCE BY THE CITY OF STOCKTON.

## GRADING NOTES:

- EARTHWORK SHALL BE PERFORMED IN ACCORDANCE WITH THE CITY OF STOCKTON STANDARDS, AND THE APPROVED SWPPP PLAN AND BOOKLET ALL FILL AREAS SHALL BE TESTED AS REQUIRED BY THE CITY OF STOCKTON, AND SHALL BE PAID FOR BY THE CONTRACTOR.
- THE CITY SHALL BE RESPONSIBLE FOR COST OF INITIAL TEST FOR MOISTURE DENSITY CURVE. IF THE FIRST TEST FAUS, THE CONTRACTOR SHALL BE RESPONSIBLE FOR COST OF ALL SUBSEQUENT CURVES AND TESTS.
- AFTER ROUGH GRADING EXCESS EARTH GENERATED FROM UNDERGROUND INSTALLATION AND ROADWAY GRADING SHILL BE PLACED ON THE SOCCER FIELD AS DIRECTED BY THE ENGINEER.
- 4 DELETED
- STOCKPILES OF EXISTING DELETERIOUS MATERIAL SHALL BE DISPOSED OF UNDER THE DIRECTION AND SUPERVISION OF THE OWNER AND OWNER'S SOIL ENGINEER.
- 7. WALL GRADES AND STEP LOCATIONS PER LANDSCAPE ARCHITECTURAL PLANS.

- THE CONTRACTOR SHALL FURNISH, INSTALL, OPERATE AND MAINTAIN ALL MACHINERY APPLIANCES, AND EQUIPMENT TO MAINTAIN ALL EXCAMATIONS FREE FROM MATER DURING CONSTRUCTION. THE CONTRACTOR SHALL DISPOSE OF THE MATER SO AS NOT TO CAUSE A MAIS OF PUBLIC, OR PHYRIAE PROPERTY, OR THE APPROVED SWIPP OR TO CAUSE A NUISANCE OR MEMORE TO THE PUBLIC OR VOLATE THE LAW. THE DEMITERING SYSTEMS SHALL BE INSTALLED MODERATED FROM THE CONTRACTOR OF THE STRUCTURES OF PROPERTY. ALL COST FOR DEMATERING SHALL BE INCLUDED BY THE CONTRACTOR STRUCTURES OR PROPERTY. ALL COST FOR DEMATERING SHALL BE INCLUDED BY THE DEMAN DOWN A MINIMUM OF 1 FOOT BELOW THE BOTTOM TO EXCAMATIONS TO MAINTAIN THE UNDISTURBED STATE OF NATURAL SOLES AND ALLOW THE PLACEMENT OF ANY FILL TO THE SPECIFIED DENSITY. THE CONTRACTOR SHALL HAVE ON HAND, PUMPING EQUIPMENT AND MACHINEY IN GOOD WORKING CONDITION FOR BERCENCES AND SHALL HAVE WORKINEY NAMED WORKING TO MOTION FOR THE PLACEMENT OF ANY FILL TO THE SPECIFIED DENSITY. THE CONTRACTOR SHALL HAVE ON HAND, PUMPING EQUIPMENT AND MACHINEY IN GOOD WORKING CONTINON FOR BERCENCES AND SHALL HAVE WORKINEN ANALIBLE FOR IT'S OPERATION. DEMATERING SYSTEMS SHALL OPERATE CONTINUOUSLY UNIT. BEACHES OF PERATION. DEMATERING SYSTEMS SHALL OPERATE CONTINUOUSLY UNIT. BEACHES OF PERATION.
- THE CONTRACTOR SHALL CONTROL SURFACE WATER TO PREVENT ENTRY INTO EXCAVATIONS. AT EACH EXCAVATION, A SUFFICIENT NUMBER OF TEMPORARY OBSERVATION WELLS TO CONTINUOUSLY CHECK THE GROUNDWATER LEVEL SHALL BE PROVIDED.
- SUMPS SHALL BE NO DEEPER THAN 5 FEET AND SHALL BE AT THE LOW POINT OF EXCAVATION. EXCAVATION SHALL BE GRADED TO DRAIN TO THE SUMPS.

- THE CONTROL OF GROUNDWATER SHALL BE SUCH THAT SOFTENING OF THE BOTTOM OF EXCAUTIONS, OR FORMATION OF "QUICK" CONDITIONS OR "ROLLS", DOES NOT OCCUR. DEMATERING STSTEMS SHALL BE DESIGNED AND OPERATED SO AS TO PREVENT REMOVAL OF THE INSTURAL SOULS. THE RELESS OF GROUNDWATER AT ITS STATIC LEVEL SHALL BE PERFORMED IN SUCH A MANDRER AS TO MAINTAIN THE UNDESTRIBED STATE OF THE MATURAL FOUNDATIONS SOULS, PREVENT DISTURBANCE OF COMPACTED BACKFILL, AND PREVENT FLOTATION OR MOVEMENT OF STRUCTURES, PIPELINES AND SEMENS, IF AN NIPLES (NATIONAL POLLUTIANT DISCHARGE ELIMINATION SYSTEM) PERMIT IS REQUIRED FOR DISPOSAL OF WATER FROM CONSTRUCTION DEMATERING ACTIVITIES, IT SHALL BE OBTAINED BY THE CONTRACTOR PRIOR TO ANY DEWATERING ACTIVITIES.
- OBTAINED BY THE CURIFICATION FOLD AND LIBRALETING PALITIES.

  ONE HUNDRED PERCENT STANDBY PUMPING CAPACITY SHALL BE AVAILABLE ON SITE AT ALL TIMES AND SHALL BE CONNECTED TO THE DEWATERING SYSTEM PIPING TO PERMIT IMMEDIATE USE. IN ADDITION, STANDBY AUXILIARY EQUIPMENT AND APPLIANCES FOR ALL ORDINARY EMERGENCY POWER OF PERFORM AND COMPETENT WORKMAN FOR OPERATION AND AUTOMATIC SHITCH OVER TO THE EMERCENCY COMPETER CEMERATION AND AUTOMATIC SHITCH OVER TO THE EMERCENCY CONVERENCE CHESTAND AND AUTOMATIC SHITCH OVER TO THE EMERCENCY CONVERT OF WENN NORMAL POWER FAULS.

  DEMATERING SYSTEMS SHALL NOT BE SHALT DOWN BETWEEN SHIFTS, ON HOLIDAYS, ON WEEKENDS, OR OURING WORK STOPPAGES.
- THE CONTRACTOR SHALL USE A SEDIMENTATION BASIN OR TANK TO REMOVE SEDIMENT FROM THE DEWATERING WATERS PRIOR TO DISCHARGE.

NOTE:

HE CITY OF STOCKTON BUILDING OFFICIAL HAS INDICATED THAT PER SEC. 13-301(A)

OF THE STOCKTON MUNICIPAL CODE, A BUILDING FERMIT SHALL BE REQUIRED VA

FIRE BUILDING PERMIT PROCESS FOR THE INSTALATION OF PARK LIGHT SYSTEM

(ELECTRICAL FERMIT), SHITHER, SAND INSTALATION OF PARK LIGHT SYSTEM

(ELECTRICAL FERMIT), SHITHER, SAND INSTALATION OF MALL BE INSPECTED BY A

CITY OF STOCKTON BUILDING SAND INSTALATION OF MALL BE INSPECTED BY A

CITY OF STOCKTON BUILDING FOR THE PARK SHITHER THAT ALL EQUIPMENT AND DESIGN COMPUSES WITH CPSC

AND ASTM GUIDELINGS FOR SHETY. THE CONTRACTOR SHALL HAVE THE

INSTALATION INSPECTED BY A CERTIFIED PLAYGROUND SAFETY INSPECTOR WHO WILL

PROVIDE A LETTER TO THE CITY OF STOCKTON STATING THE PLAYGROUND


INSTALLATION MEETINGS ALL SAFETY REQUIREMENTS.

# **LEGEND**


	EXISTING	PROPOSED	FUTURE
WATER VALVE		->>-	-04-
FIRE HYDRANT		<b>©</b>	0
CATCH BASIN (STREET)		N/A	(W)
DROP INLET (PARK)			
STANDARD MAINTENANCE HOLE			
WATER LINE			
SANITARY SEWER	8"SS	- 8°SS -	835
STORM DRAIN	12"50]	(12°SD)	(12°SD)
TYPICAL SIGNAGE	-0-	-0-	
SURVEY MONUMENT		•	49
UTILITY BOX	C3		N/A
DIRECTION OF FLOW	.003	.003	.003
TOP OF CURB ELEVATION	68.34	∖68,34	\58.34
ORIGINAL GROUND	106.82	N/A	N/A
1' CONTOURS	32	32	N/A
CURB, GUTTER AND SIDEWALK	COMMUNICACIONAL STATE OF THE ST	750COSC	CHARGO A CARGO
TYPICAL RETURN WITH HANDICAP RAMP			1
STORM DRAIN MANHOLE NUMBE	ER	< <li>◇</li>	
4' HIGH HANDRAIL	N/A		N/A

# **ABBREVIATIONS**

ABRV.	DESC.	ABRV.	DESC.
ø	AT	MH	MAINTENANCE HOLE
AB	AGGREGATE BASE	MIN	MINIMUM
AC	ASPHALT CONCRETE	N	NORTH
ANG.	ANGLE	NTS	NOT TO SCALE
AP	ANGLE POINT	OG	ORIGINAL GROUND / GRADE
BC	BEGIN CURVE	P	PAVEMENT
BDRY	BOUNDARY	PP	POWER POLE
BSL	BUILDING SET BACKLINE	PL	PROPERTY LINE
BVC	BEGIN VERTICAL CURVE	PRC	POINT OF REVERSE CURVATU
C & G	CURB AND GUTTER	PT	POINT
CIP	CAST IN PLACE	PUE	PUBLIC UTILITY EASEMENT
E	CENTER LINE	PVC	POLYVINYL CHLORIDE PIPE
čo	CLEAN OUT	RCP	REINFORCED CONCRETE PIPE
CONC	CONCRETE	RET	RETURN
			RADIUS
C.O.S.	CITY OF STOCKTON	R	RESISTANCE VALVE
CB	CATCH BASIN	RV	
DIA	DIAMETER	R/W SHT	RIGHT-OF-WAY
DIP	DUCTILE IRON PIPE	SHI	SHEET
DW	DRIVEWAY	SNS	STREET NAME SIGN
D OR SD	DRAIN OR STORM DRAIN	STA	STATION
EC	END OF CURVE	STD	STANDARD
ELEV	ELEVATION	S/W	SIDEWALK
EP	EDGE OF PAVEMENT	S/W	SEWER
ESMT	EASEMENT	SS	SANITARY SEWER
EVC	END OF VERTICAL CURVE	TC	TOP OF CURB
		TEMP	TEMPORARY
EX OR EXIST FH	EXISTING	TG	TOP OF GRATE
	FIRE HYDRANT	THRU	THROUGH
FL	FLOW LINE	77	TRAFFIC INDEX
GB	GRADE BREAK	TOW	TOP OF WALL
HORIZ	HORIZONTAL	TPE	TREE PLANTING EASEMENT
HP	HIGH POINT	TYP.	TYPICAL
HPS	HIGH PRESSURE SODIUM		VERTICAL
INV	INVERT	VERT VCP	
IRR	IRRIGATION		VITRIFIED CLAY PIPE
LF	LINEAL FEET OR LINEAR FEET	WS	WATER SERVICE
LP	LOW POINT	W	WATER
MAX	MAXIMUM	±	PLUS OR MINUS (NOT EXACT,

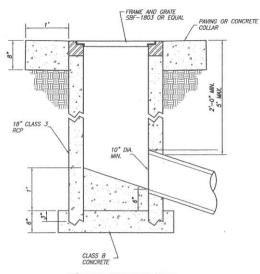

18" STORM DRAIN DROP INLET

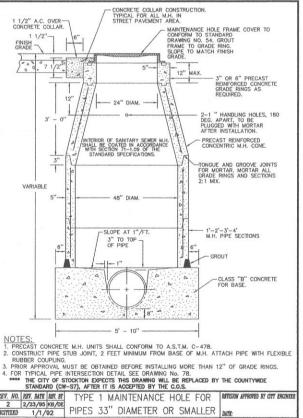

REV. NO. REV. DATE SET. BT TYPE 1 MAINTENANCE HOLE FOR DICTIVED 1/1/92 PIPES 33" DIAMETER OR SMALLER DIGITIZED 1/1/92
DWG. BY RC SCALE CITY OF STOCKTON DEPARTMENT OF PUBLIC WORKS DRAWING NO. SUPERCEDES DWG, DATED 11/8/80 NONE



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# S.L. FONG PARK

NOTE SHEET


DEPARTMENT OF PUBLIC WORKS CITY OF STOCKTON, CALIFORNIA





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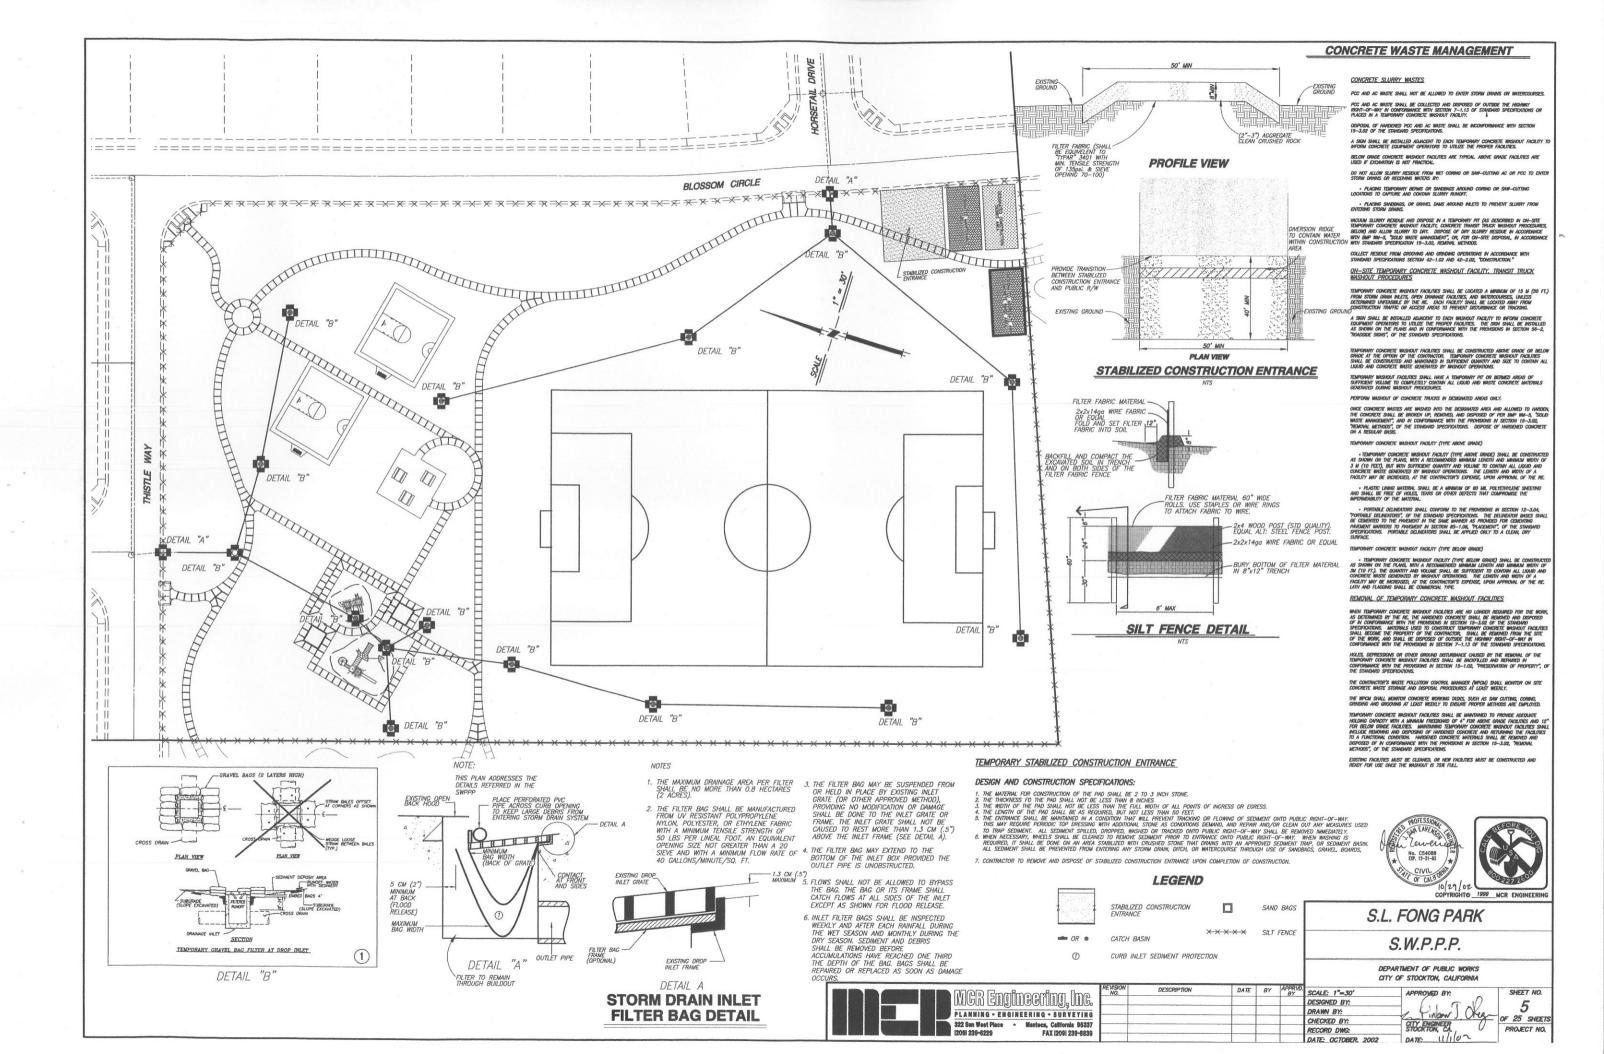
APPROVED BY: Cindow J. O'Regarding STOCKTON, CA. DATE ULLEN


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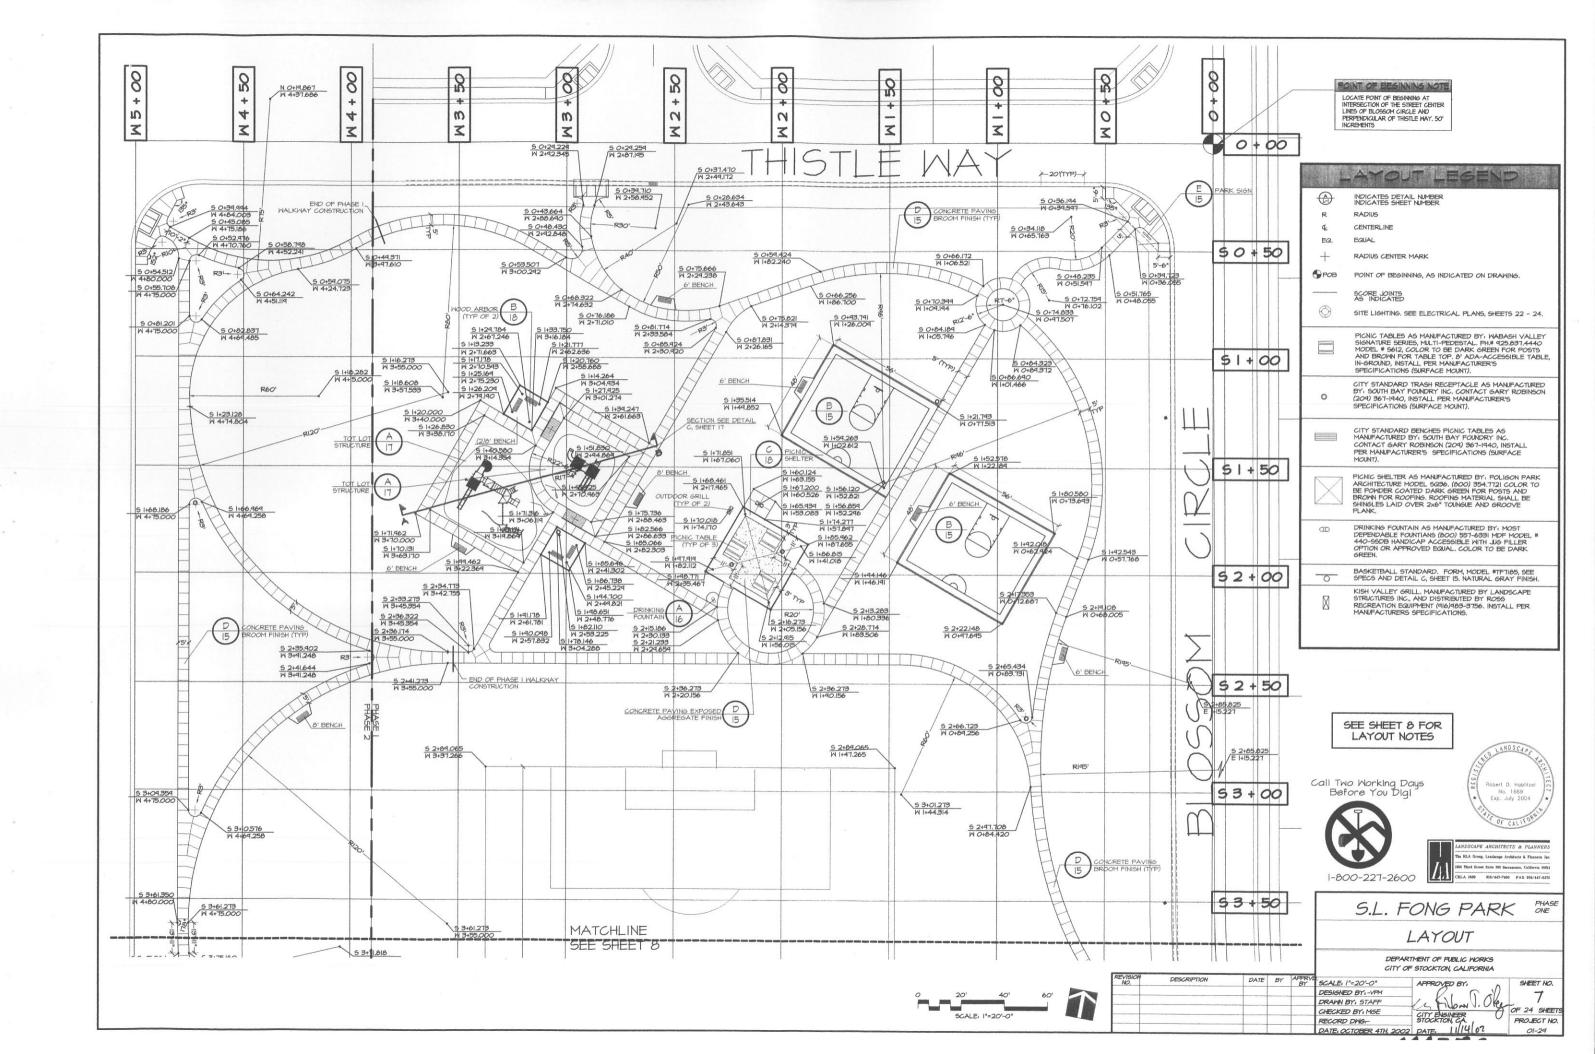





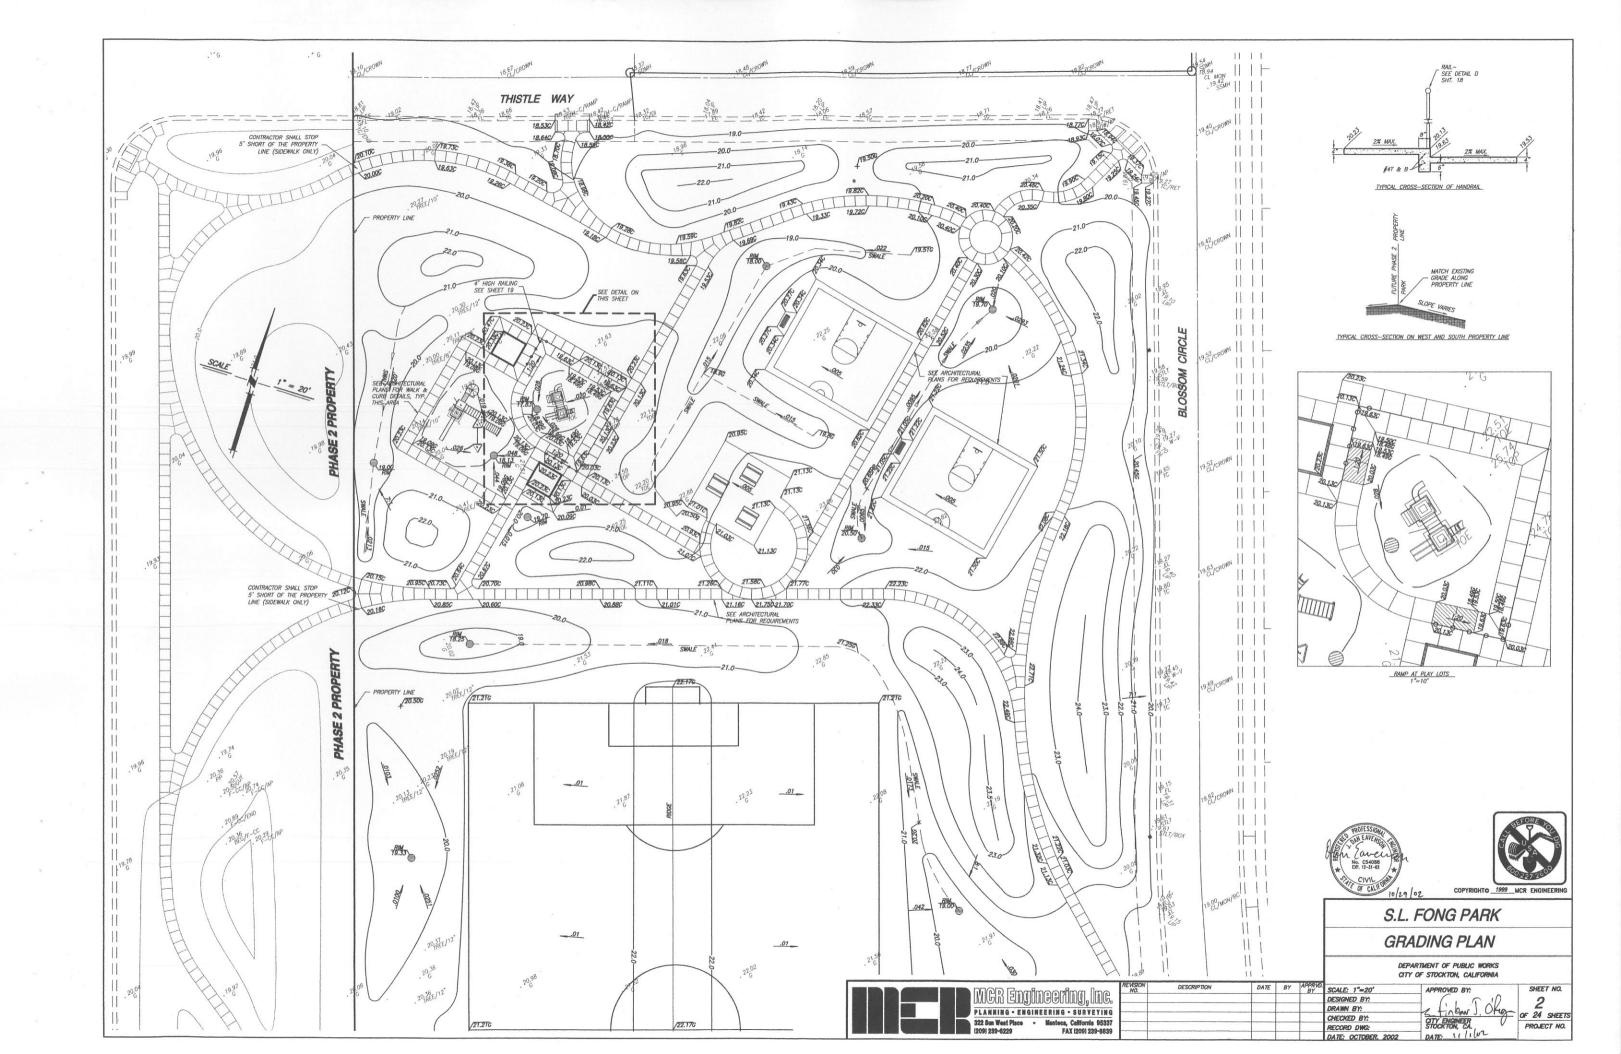


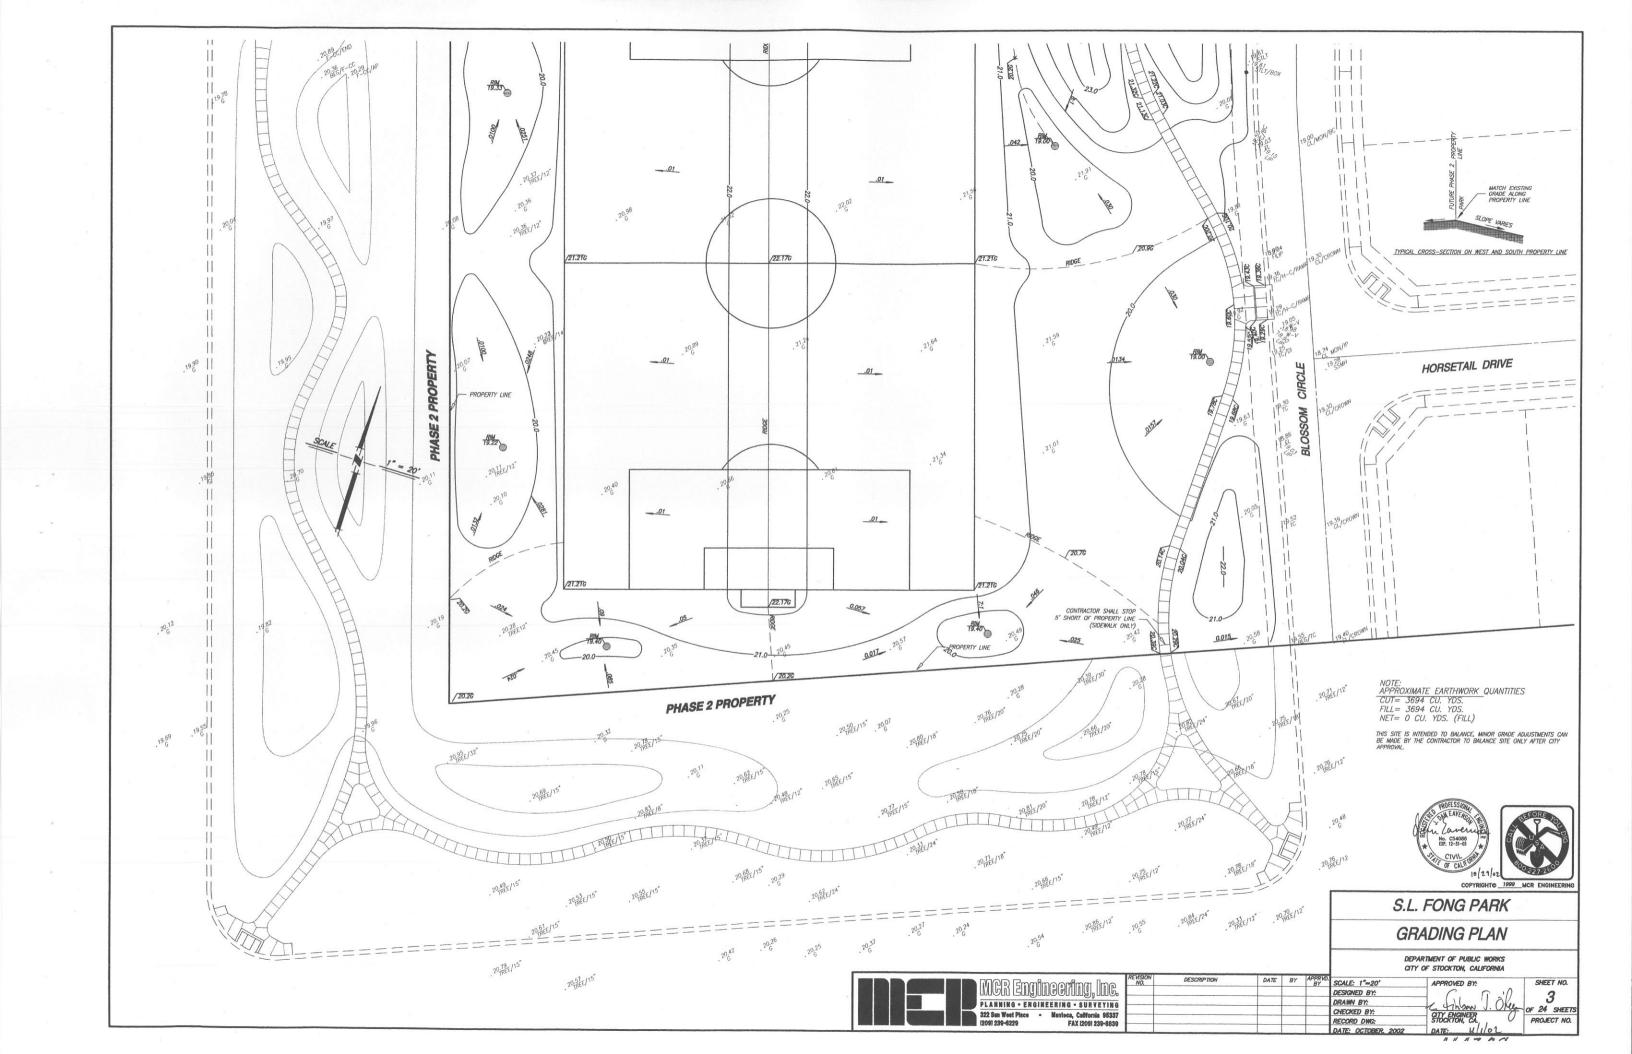


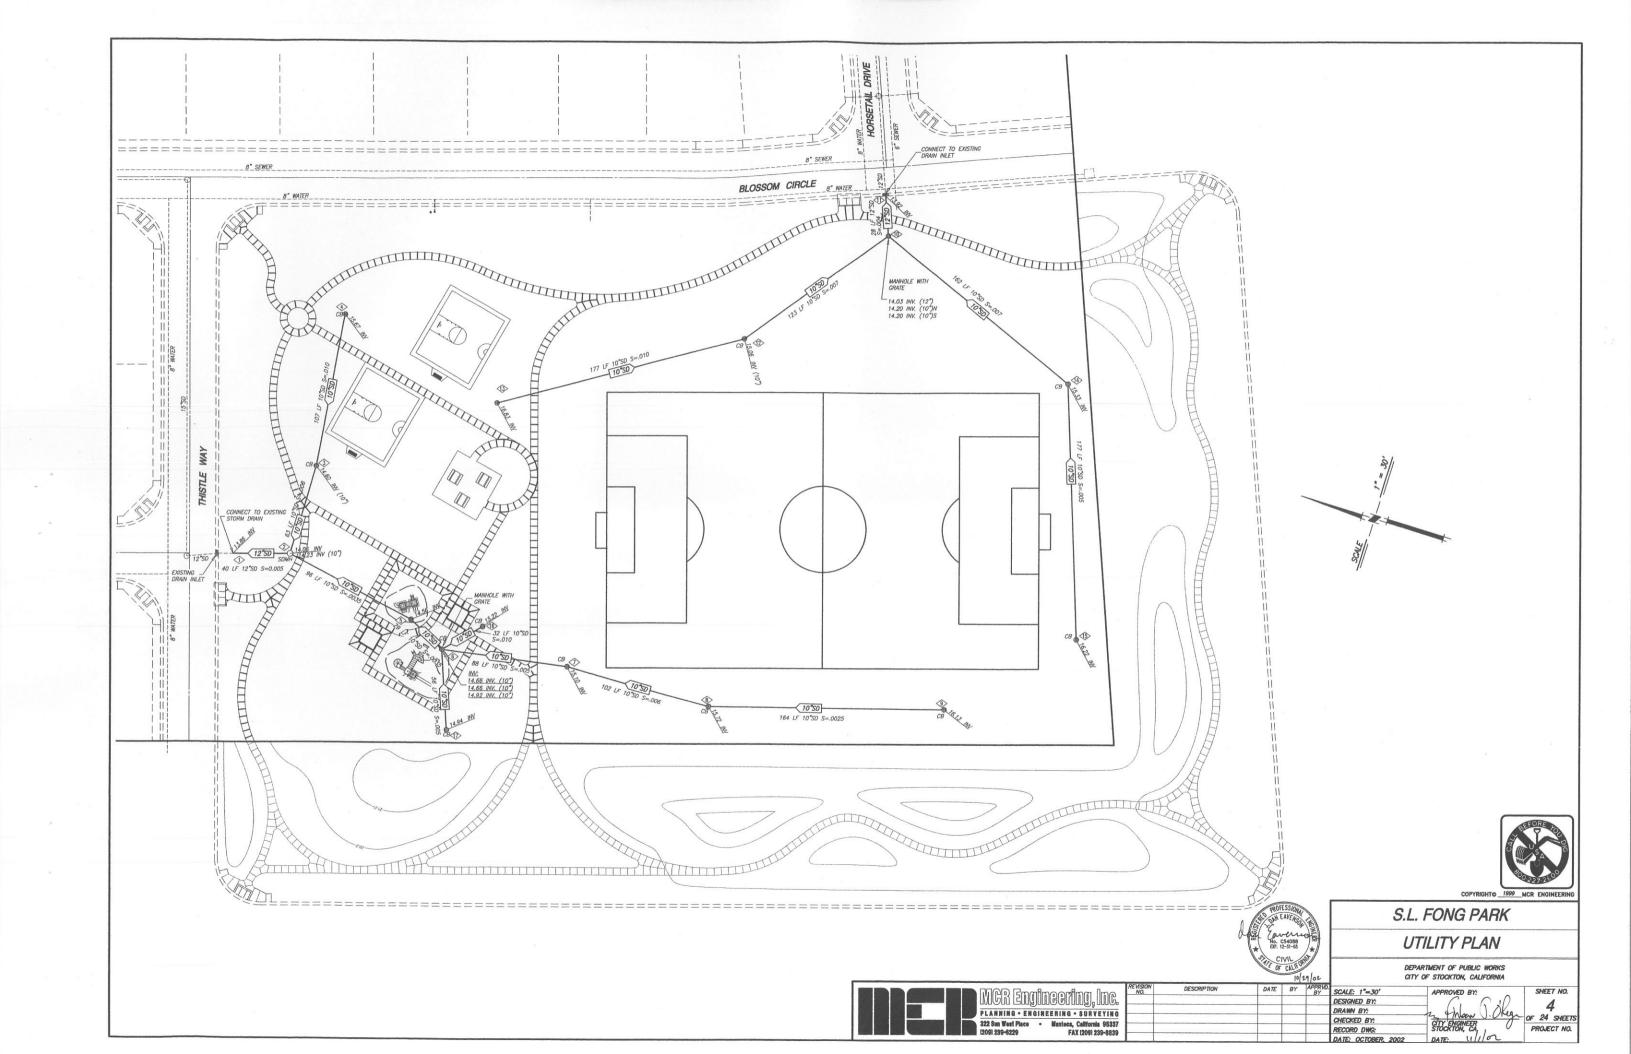


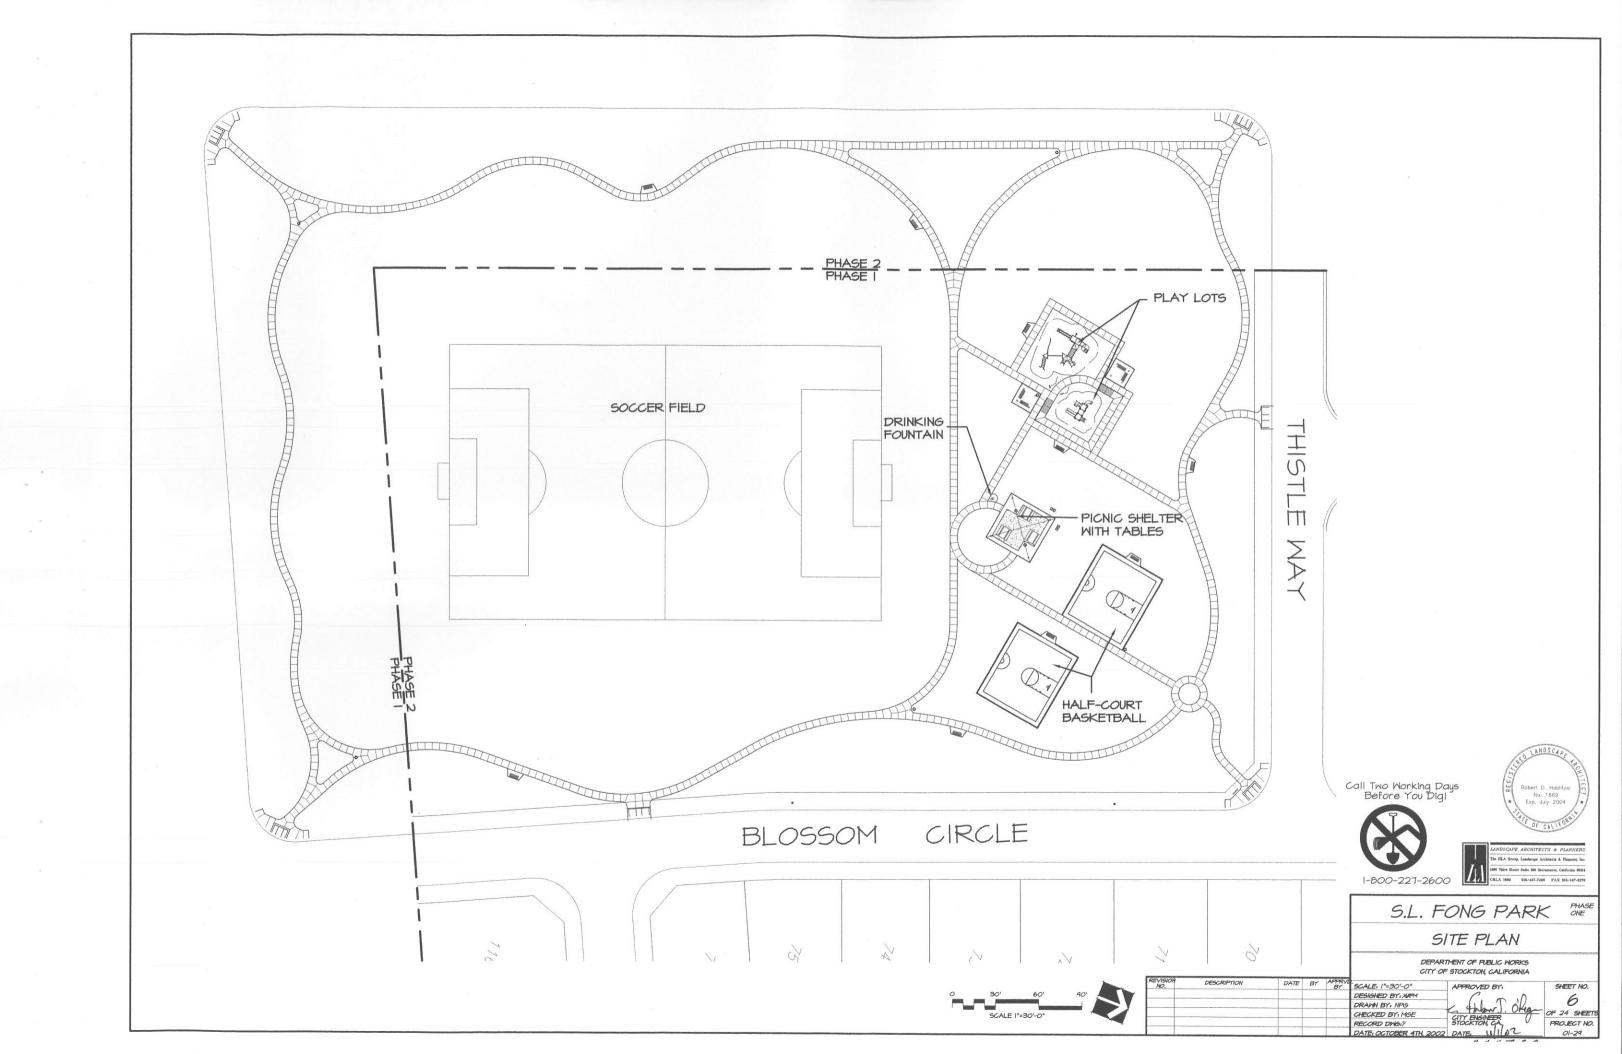


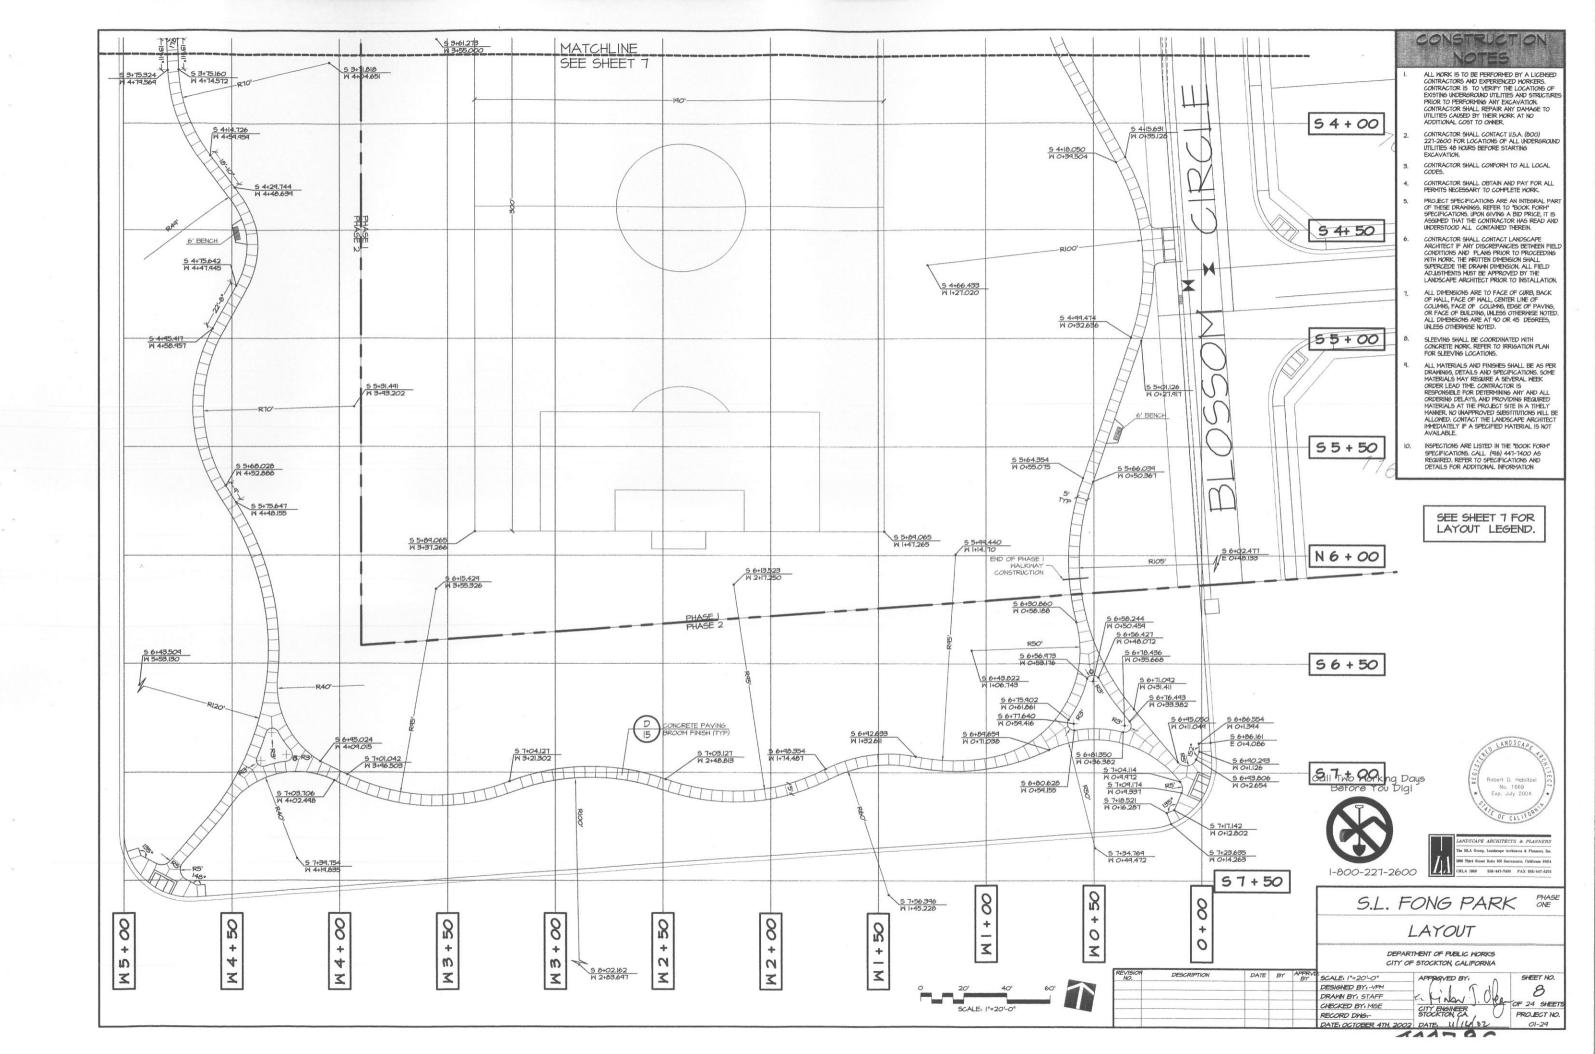

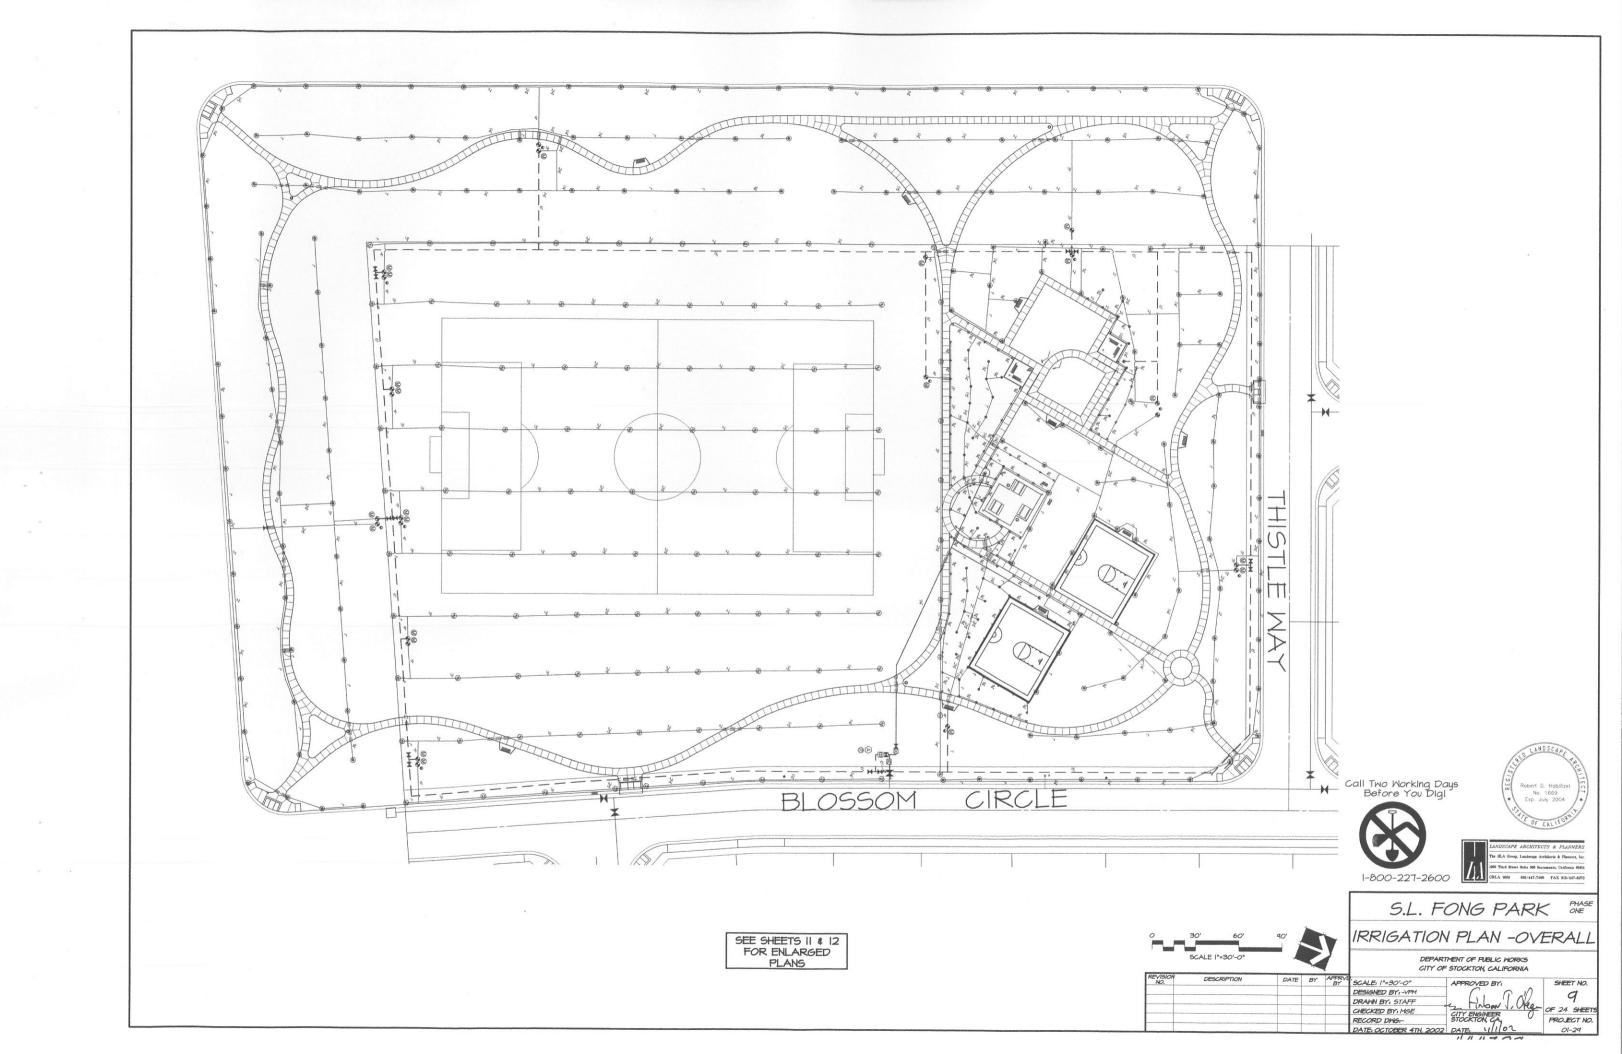

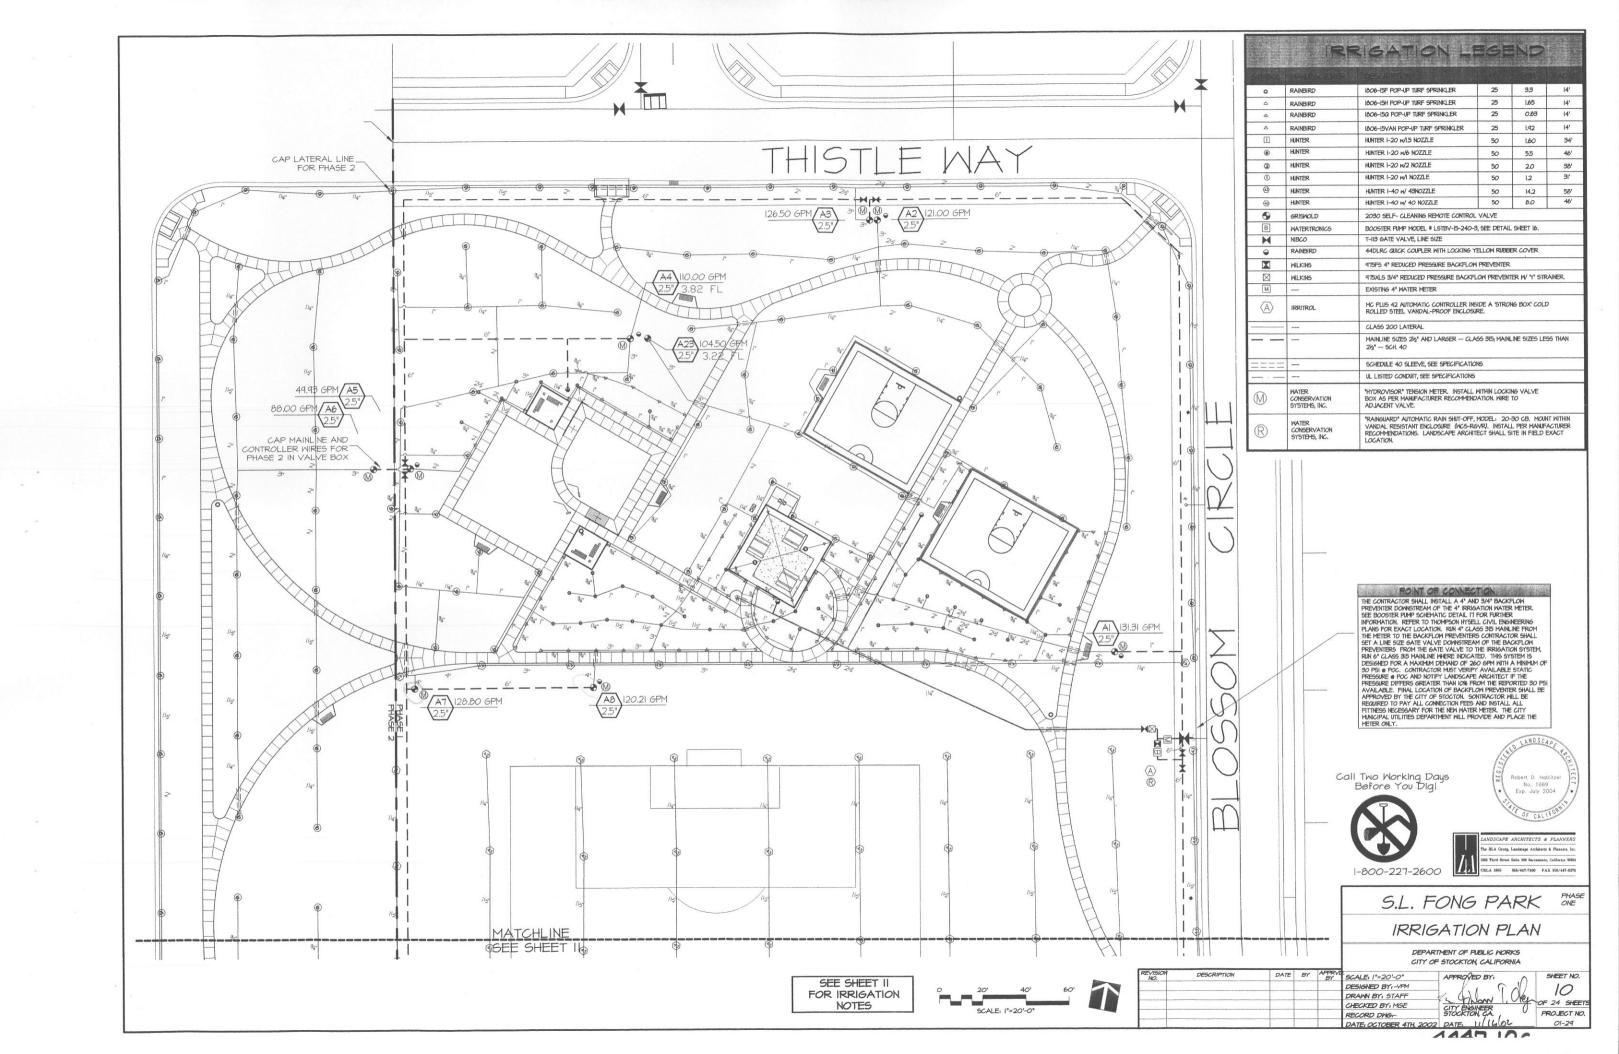

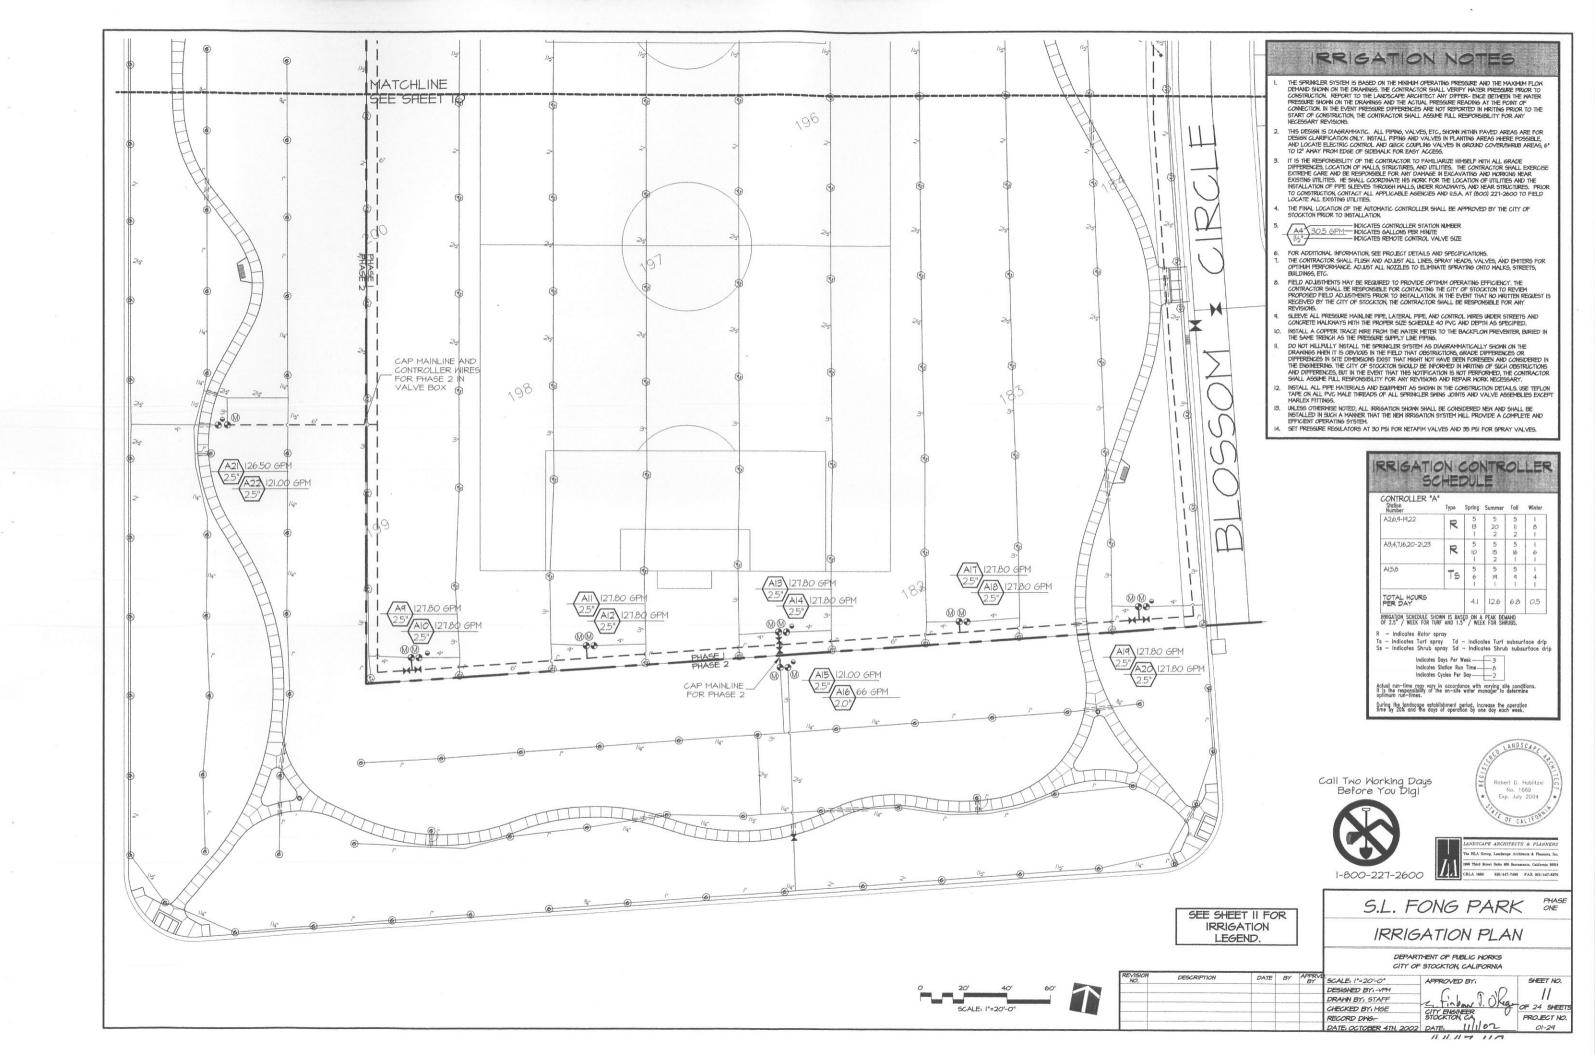

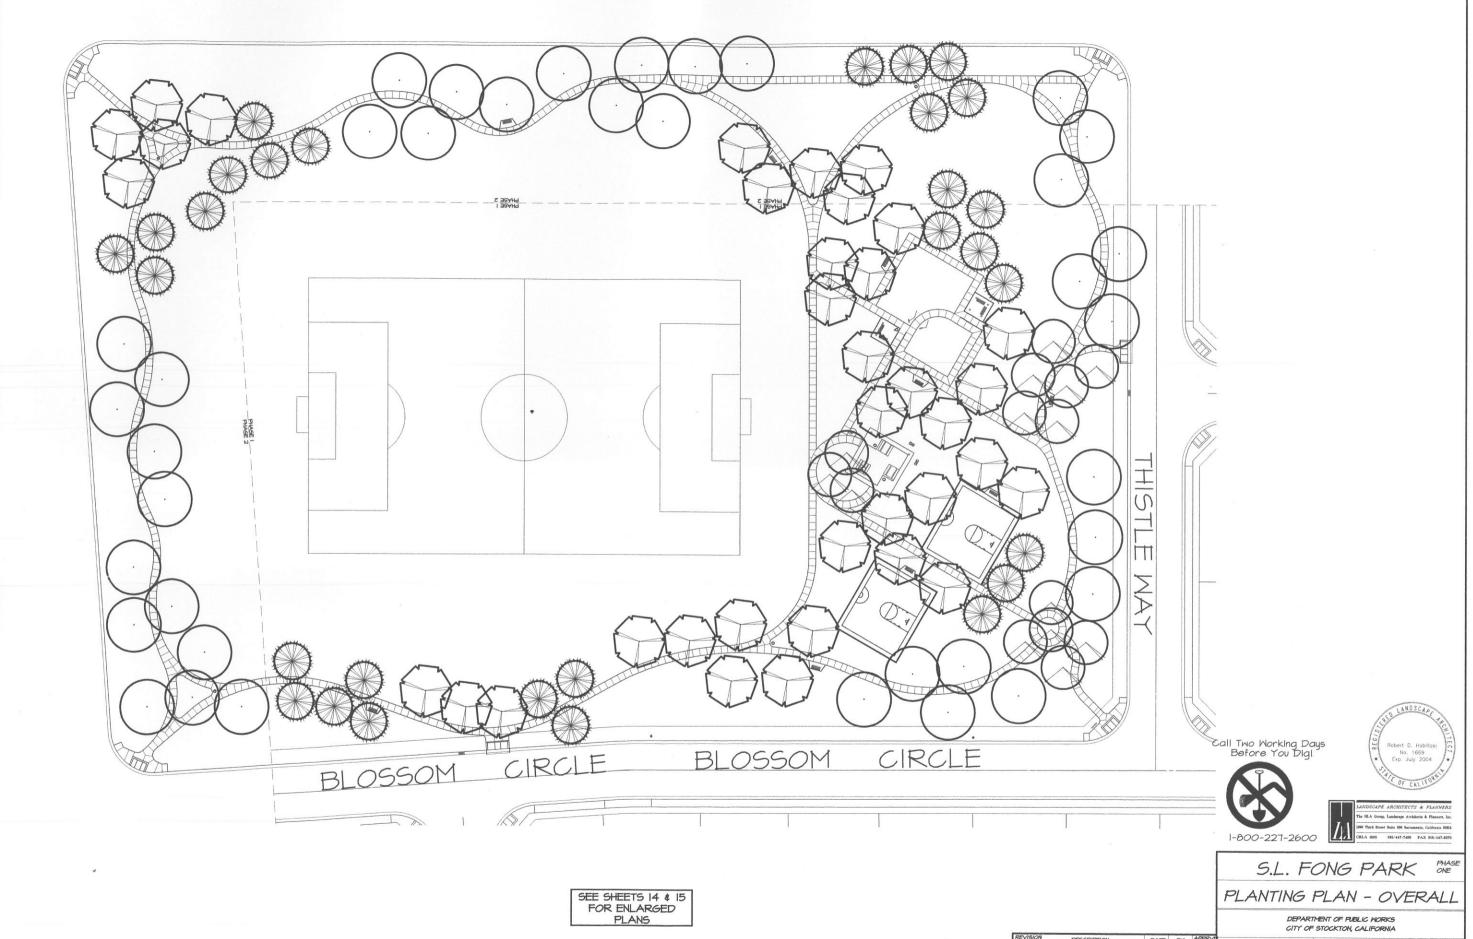

60' 40'

REVISION DESCRIPTION DATE BY APPRVI.

NO. DESCRIPTION DATE BY APPRVI.

DESCRIPTION DESCRIP

# STOCKING APPROVED BY:

O BY: -VPM


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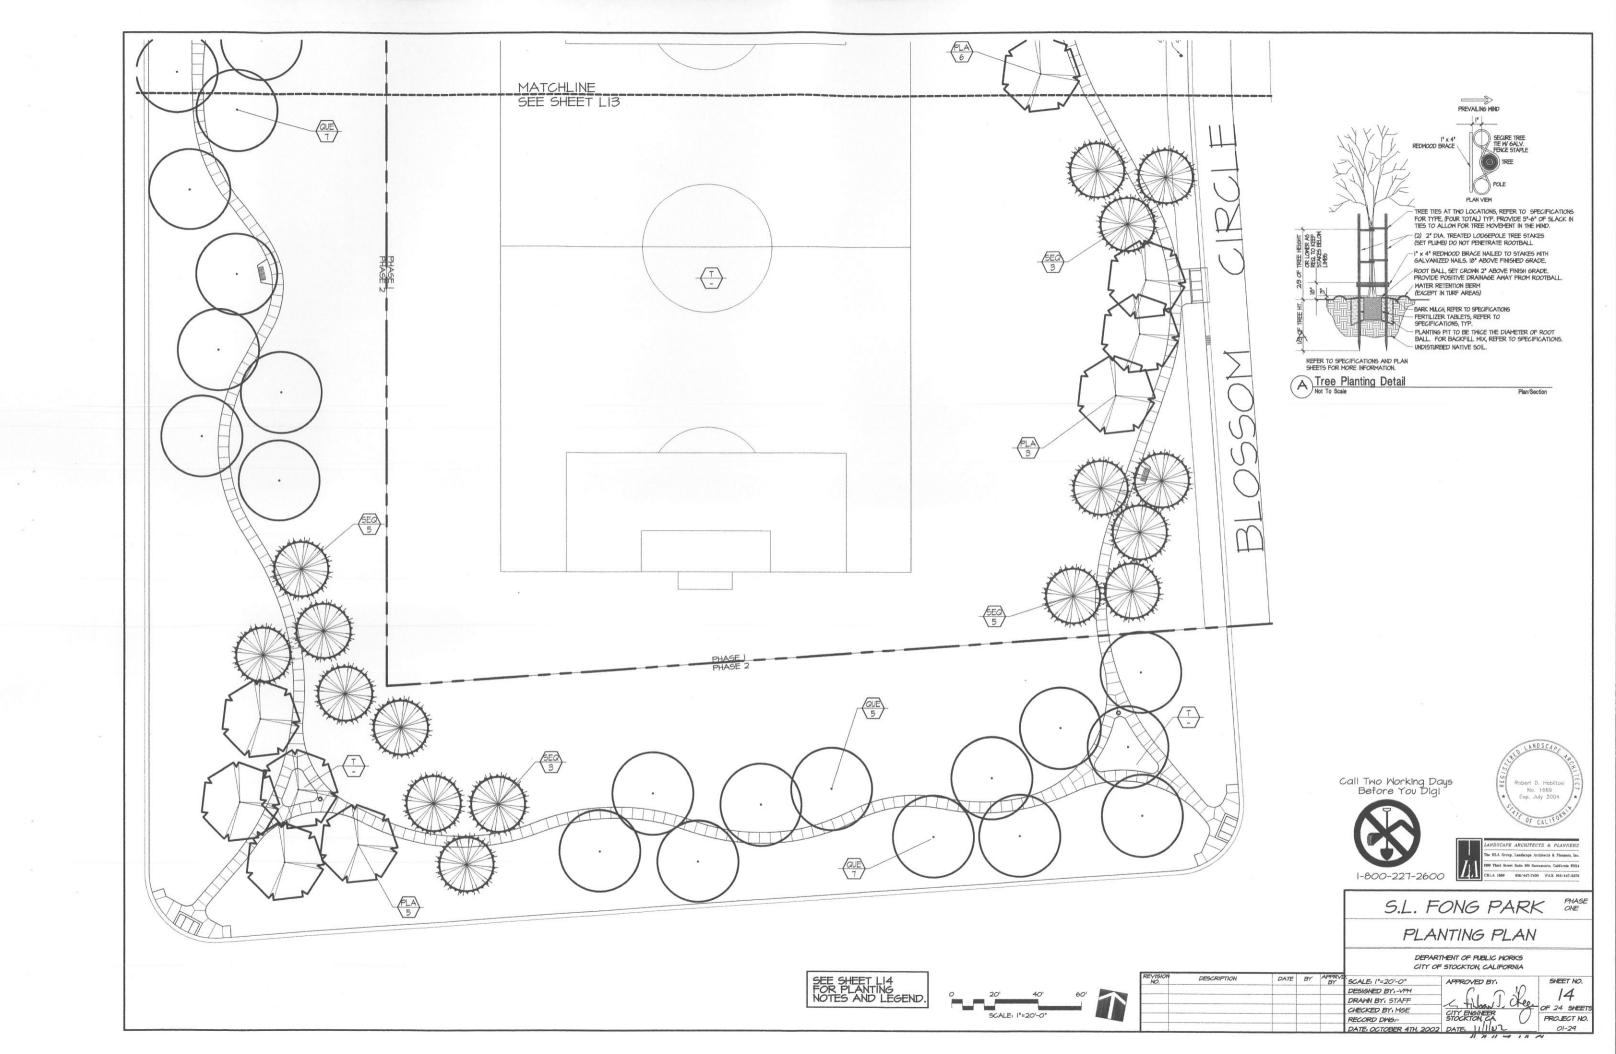
BY: MGE


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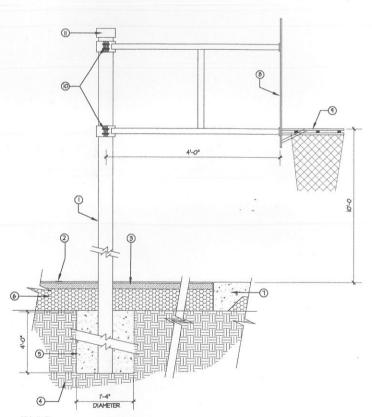




KEY NOTES

- CONCRETE PAVING WHERE APPLICABLE MED. BROOM FINISH ALL EXPOSED SURFACES
- TOOLED EDGES TYP.
- #4 REBAR, CONT. A/C PAVING AND COURT SURFACING- SEE SPECS.
- CLASS II AGG. BASE COMPACTED TO 45% R.D. COMPACTED SUBGRADE TO 45% R.D.
- Basketball Court Paving/Curb

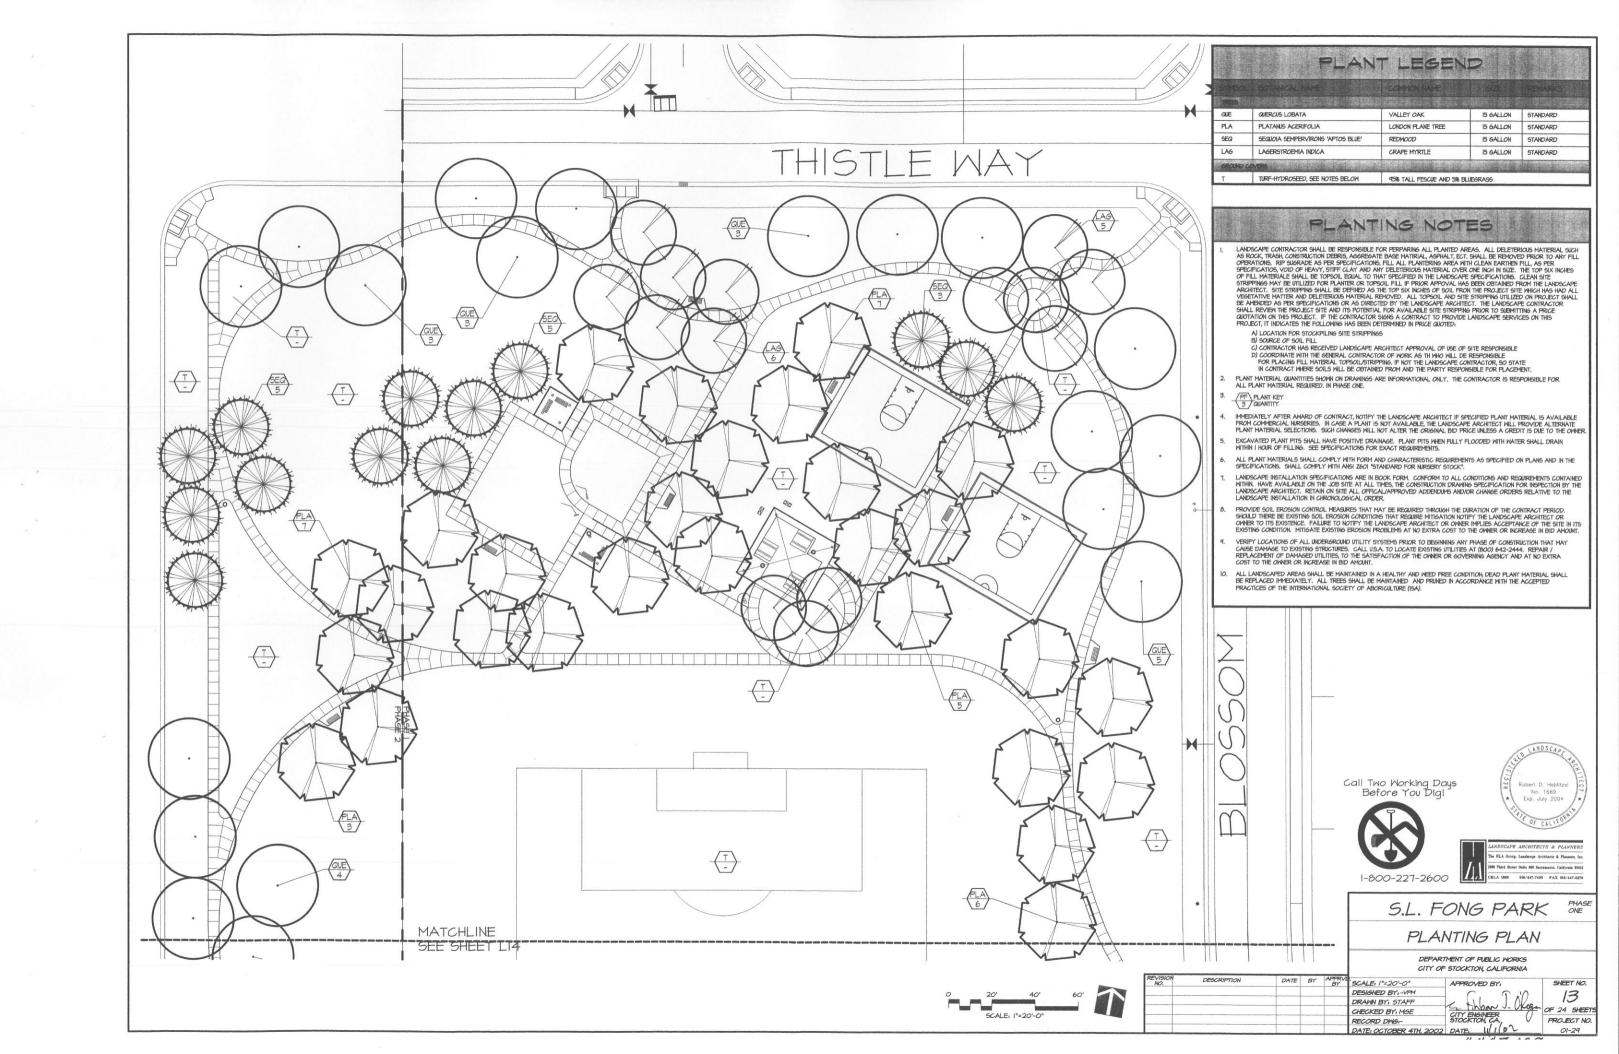
Scale: T= 1-0"

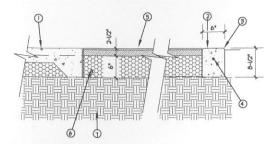

- BASKETBALL STANDARD POLE.
- COURT BOUNDARY LINE. A/C PAYING AND COURT SURFACING SEE SPECS.
- COMPACTED SUBGRADE TO 45% R.D.
  - CONCRETE FOOTING, INSTALL PER MANUFACTURER'S SPECIFICATIONS. TOP OF FOOTING TO BE BELOW AGGREGATE BASE.
- AGGREGATE BASE, SEE SPEC'S.
- CONCRETE SIDEMALK OR CURB

  1/4" STEEL PLATE FAN SHAPED BACKBOARD, HOT GALVANIZED FINISH
- SUPER GOAL RIM OR EQUAL.
- ADJUSTABLE CLAMP (TYP.)


Basketball Standard

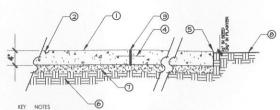

(1) CONCRETE PAVING-LIGHT BROOM FINISH PERPENDICULAR TO MAIN DIRECTION OF TRAVEL. FINISH SHALL BE EXPOSED AGGREGATE UNDER PICNIC SHELTER, SEE LAYOUT.

- 2 %" x %" DEEP SCORE JOINT-8'X8' O.C.
  3 %" FIBER EXPANSION JOINT- 40' O.C. MAXIMUM
- ) 12" LONG #3 DOWEL @ 24" O.C.; SLEEVE ONE END ) JOINTS AND EDGES SHALL BE TOOLED.
- SUBGRADE COMPACTED TO 90% R.D.
- (1) 2" SAND BASE TYP. (8) FINISH GRADE

Concrete scale 141-01 Concrete Paving

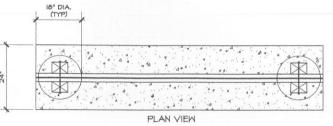



DESCRIPTION

18.0

0-

KEY NOTES

3.0

BASKETBALL STANDARD, SEE SPECIFICATIONS FOR MANUFACTURER AND MODEL NUMBER, SEE DETAIL C/16.


— 22.0 <del>/</del> 12.0 <del>/</del> 22.0

6' STRAIGHT BENCH, REFER TO LAYOUT LESEND FOR MANEACTURER AND MODE, IMMEER.
 2" MIDE PAINTED PLAYING LINES, SEE SPECS FOR COLOR AND MANEACTURER, TYP.

Basketball Court Area

ASPHALT PAVING, PROVIDE EXPANSION JOINTS AS SHOWN. SEE DETAIL A SHEET IS.

ASPHALT PAVING, SEE DETAIL A, SHEET 16 CONCRETE PAVING, SEE DETAIL D SHEET L 16.

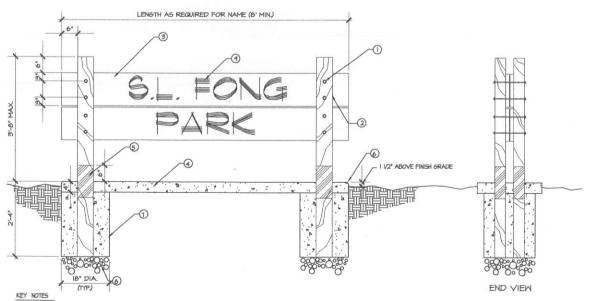

1/2" DIAMETER GALVANIZED BOLTS, WASHERS AND NUTS

- (2) 4"x6" RECYCLED PLASTIC LUMBER POSTS
- 3 2"xi2" RECYCLED PLASTIC LUMBER WITH I/2" DEEP ROUTED LETTERS ON STREET FACING SIDE

Park Sign

Not to Scale

- (4) CONCRETE WITH 6"x6" (loxio) WW.F. LIGHT BROOM FINISH
- (TYP)
- (6) 3/4" CHAMPER (TYP.) (7) CONCRETE FOOTING
- (8) AGGRAGATE BASE COMPACTED 90%
- (4) SIGN LETTERS AND FONT TO BE SELECTED BY THE CITY OF STOCKTON.



Call Two Working Days Before You Dig!



1-800-227-2600




S.L. FONG PARK ONE


DETAIL SHEET

DEPARTMENT OF PUBLIC WORKS CITY OF STOCKTON, CALIFORNIA

SCALE: 1"=20'-0" DESIGNED BY .- VPM DRAWN BY: STAFF CHECKED BY: MGE RECORD DWG-

SHEET NO. APPROVED BY

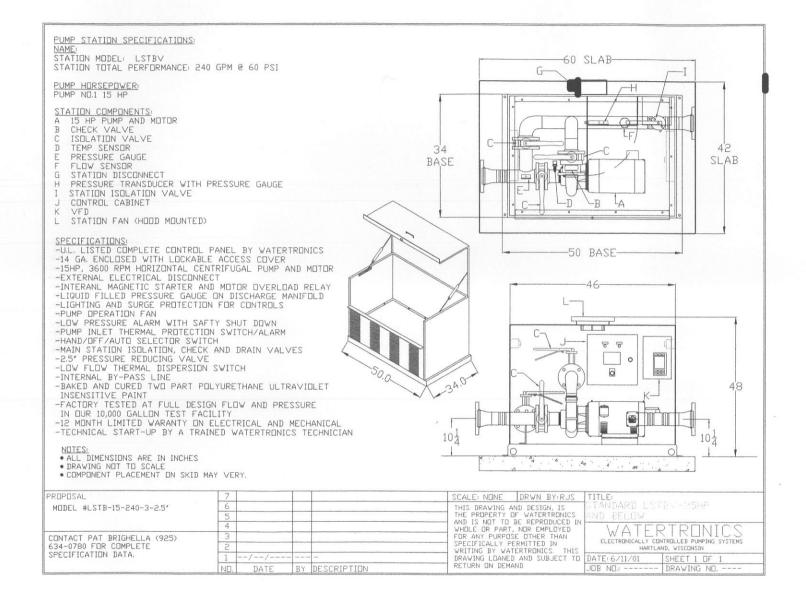

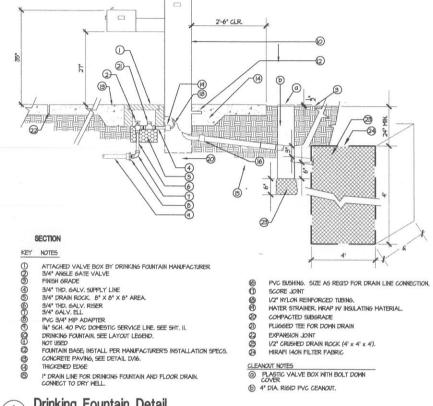



Plan / Section








S.L. FONG PARK PHASE ONE


DEPARTMENT OF PUBLIC WORKS

DETAIL SHEET

CITY OF STOCKTON CALIFORNIA

				orr or brooklong or ear broak.				
DESCRIPTION	DATE	BY	APPRVI BY	SCALE: 1"=20'-0"	APPROVED BY:	SHEET NO.		
				DESIGNED BY: -VPM	C = 10	16		
				DRAWN BY, STAFF	2 Labour 1. Okea.	10		
				CHECKED BY, MGE	CITY ENGINEER	OF 24 SHEETS		
				RECORD DWG:-	STOCKTON, CA.,	PROJECT NO.		
				DATE: OCTOBER 4TH, 2002	DATE 11/162	01-29		

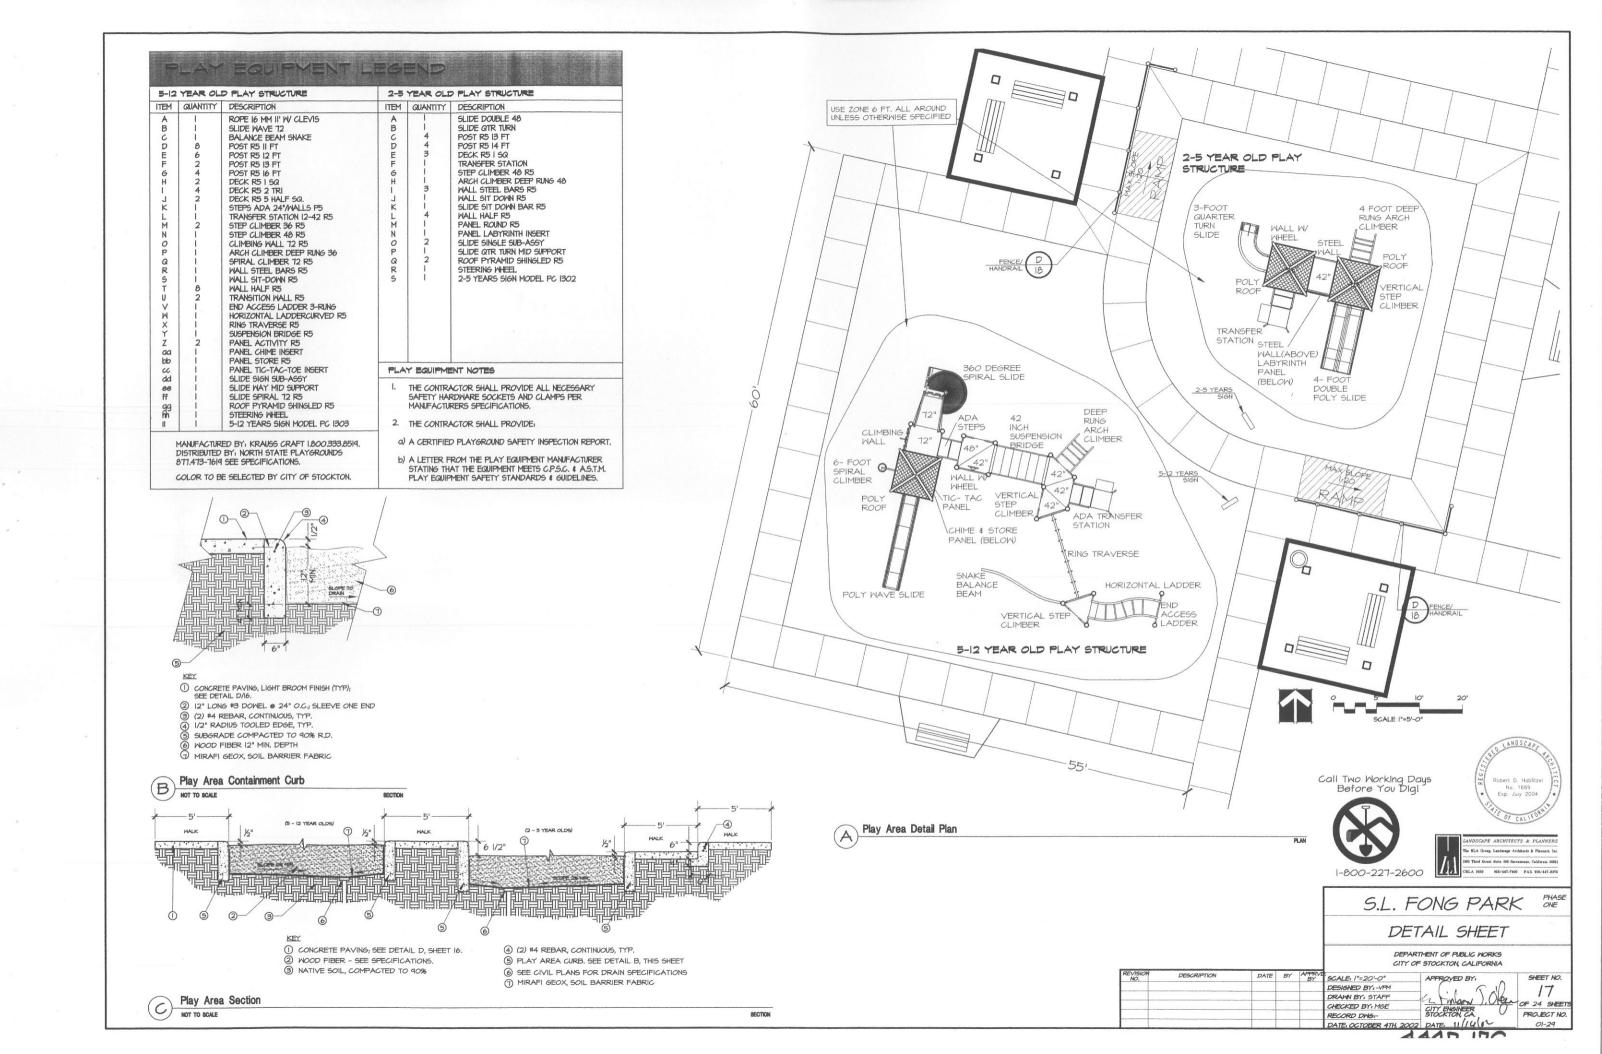

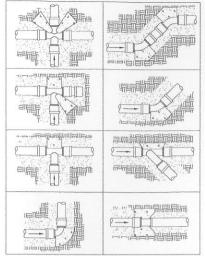


I) DO NOT COVER ANY JOINTS WITH CONCRETE.

- 2) SIZE OF THRUST BLOCKS AS SPECIFIED BY THE UNIFORM PLUMBING CODE, LATEST EDITION, FOR TYPE OF PIPE SPECIFIED.
- 3) BLOCKS TO BE PAVED AGAINST UNDISTURBED SOIL.
- 4) THRUST BLOCKS TO BE CONSTRUCTED WITH CLASS B' CONCRETE.
- 5) INSTALL THRUST BLOCKS AT THE FOLLOWING CONDITIONS;
- A) CHANGES IN DIRECTION AT, AS AT TEES AND BENDS. B) CHANGES IN PIPE SIZE AS AT REDUCERS.
- C) STOPS, AS AT LEAD ENDS.
- D) VALVES WHERE THRUSTS MAY BE EXPECTED.
- 6) REFER TO SPECIFICATIONS AND PLAN SHEETS FOR MORE INFORMATION.

A Typical Thrust Block Details

Not To Scale

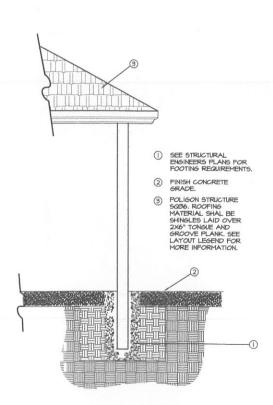



SECTION

TUBULAR STEEL FENCE/HANDRAILING DETAIL

HUNTER GREEN WITH PRIOR APPROVAL FROM

CONTRACTOR SHALL SUBMIT SHOP DRAWINGS

HIGH MOISTURE CONTENT (4% OVER OPTIMUM)

3. FIELD VERIFY ALL DIMENSIONS PRIOR TO


AND PAINT SAMPLES TO LANDSCAPE ARCHITECT PRIOR TO FABRICATION.

5. CONTRACTOR SHALL ENSURE THE SOIL HAS A

PRIOR TO PLACING CONCRETE FOOTING.

CONSTRUCTION.

/ 36" END SECTION /

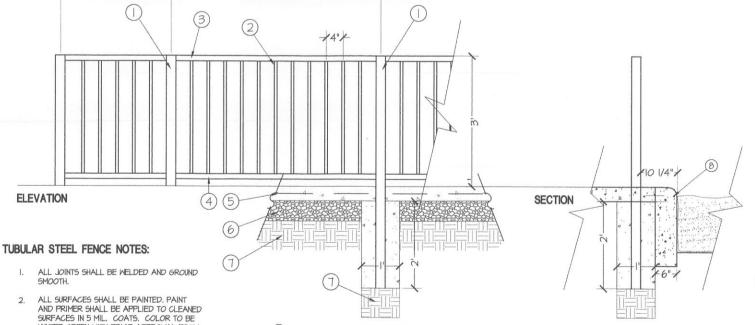

3" X 3" TUBULAR STEEL POSTS. I" X I" TUBULAR STEEL LATTICE WORK.

(4)

1 1/2" X 1 1/2" TUBULAR STEEL TOP RAIL.

8" CRUSHED DRAIN ROCK BASE - 95%

1 1/2" X 1 1/2" TUBULAR STEEL BOTTOM RAIL.

CONCRETE PAVING. SEE DETAIL A, SHEET L5

PLAY AREA CONTAINMENT CURB, SEE DEATIL B/16.

SUBGRADE COMPACTED TO 90% RELATIVE COMPACTION

-5' ON CENTER -

Call Two Working Days Before You Digl



LANDSCAPE

S.L. FONG PARK PHASE ONE

DETAIL SHEET


DEPARTMENT OF PUBLIC WORKS CITY OF STOCKTON, CALIFORNIA


SCALE: 1"=20'-0" DESIGNED BY: -VP DRAWN BY, STAFF CHECKED BY MGE RECORD DWG-

APPROVED BY

DESCRIPTION

SHEET NO. 18 OF 24 SHEET CITY ENGINEER STOCKTON, CA.

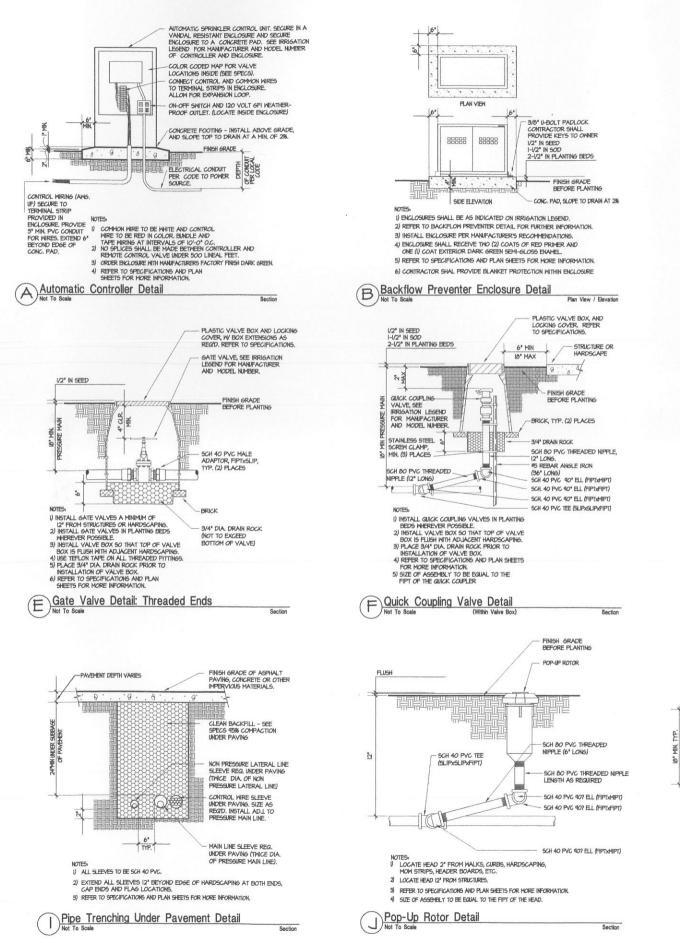

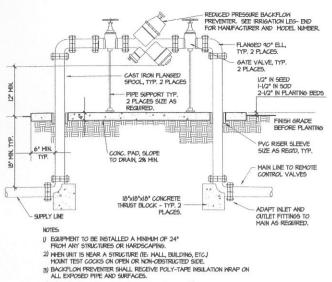


4) ALL ABOVE-GROUND ASSEMBLIES SHALL RECEIVE (2) COATS OF RED

PRIMER AND (I) COAT EXTERIOR DARK GREEN ENAMEL.


5) REFER TO SPECIFICATIONS AND PLAN SHEETS FOR MORE INFORMATION.

Backflow Preventer Detail (2 1/2" & Larger)

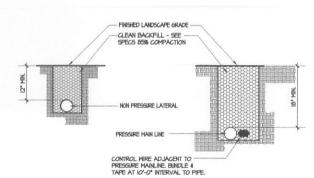

REFER TO SPECIFICATIONS AND PLAN SHEETS FOR MORE INFORMATION.



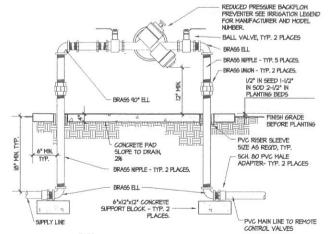


EQUIPMENT TO BE INSTALLED A MINIMUM OF 24"
FROM ANY STRUCTURES OR HARDSCAPING.


WHEN UNIT IS NEAR A STRUCTURE (IE. WALL, BUILDING, ETC.) MOUNT TEST COCKS ON OPEN OR NON-OBSTRUCTED SIDE.

BACKFLOW PREVENTER SHALL RECEIVE POLY-TAPE
 INSULATION WRAP ON ALL EXPOSED PIPE AND SURFACES.

ALL ABOVE GROUND ASSEMBLIES SHALL RECEIVE TWO (2) COATS OF RED PRIMER AND ONE (1) COAT OF EXTERIOR DARK GREEN ENAMEL.
 REFER TO SPECIFICATIONS AND PLAN SHEETS FOR MORE INFORMATION.

Backflow Preventer Detail (2" & Smaller)

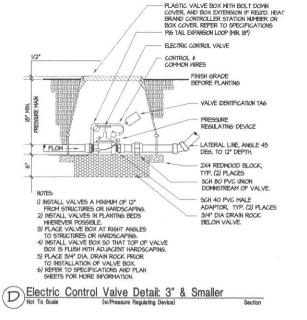

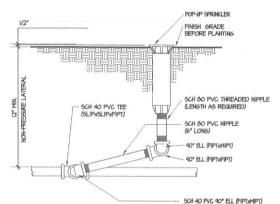

NOTES:

I LOCATE HEAD 2' FROM MALKS, CURBS, HARDSCAPINS, NOW
STRIPS, HEADER BOARDS, AND THE EDGE OF LAWN AREAS.

 LOCATE STREAM SPRAY/BUBBLERS 6" FROM ALL STRUCTURES, AND SPRAY HEADS 12" FROM ALL STRUCTURES, BUT 6" FROM ALL STRUCTURES IN GROUND COVER AREAS. 3) SIZE OF ASSEMBLY TO BE EQUAL TO THE FIFT OF THE HEAD.

4) REFER TO SPECIFICATIONS AND PLAN SHEETS FOR MORE INFORMATION

H Pop-Up Spray Detail



1-800-227-2600 S.L. FONG PARK DETAIL SHEET

> DEPARTMENT OF PUBLIC WORKS CITY OF STOCKTON, CALIFORNIA

SCALE: 1"=20'-0 APPROVED BY DESIGNED BY:-VPM DRAWN BY, STAFF CHECKED BY, MGE RECORD DWG:-

DESCRIPTION

SHEET NO. 19 OF 24 SHEE

DATE OCTOBER 4TH 2002 DATE UNINA

CITY ENGINEER STOCKTON, CA.



#### ELECTRICAL NOTES

ELECTRICAL INSTALLATION SHALL COMPLY WITH TITLE 24, CALIFORNIA CODE OF REGULATIONS, INCLUDING THE FOLLOWING:

TITLE 24, CCR, PART 2, 1997 UBC TITLE 24, CCR, PART 3, 1996 NEC TITLE 24, CCR, PART 4, 1997 UBC TITLE 24, CCR, PART 9, 1997 UBC ALL APPLICABLE LOCAL CODES.

2. ELECTRICAL CONTRACTOR SHALL VERIFY POWER SERVICE AT SITE PRIOR TO BIDDING. SERVICE TO CONFORM TO UTILITY COMPANY REQUIREMENTS.

3. ELECTRICAL CONTRACTOR SHALL PROCURE AND PAY FOR ALL LICENSES, ETC. REQUIRED TO CARRY ON AND COMPLETE THE WORK. ADDITIONALLY, HE/SHE SHALL OBTAIN ALL PERMITS NECESSARY. CITY TO PROVIDE PERMIT AT "NO COST" TO CONTRACTOR.

PROVIDE ALL LABOR, MATERIALS, TOOLS, PLANT, EQUIPMENT, TRANSPORTATION AND PERFORM ALL OPERATIONS NECESSARY FOR PROPER EXECUTION AND COMPLETION OF ALL "ELECTRICAL WORK" COVERED UNDER THIS PROJECT.

5. ALL ELECTRICAL MATERIALS SHALL BE NEW AND LISTED WITH THE UNDERWRITERS' LABORATORIES, INC., SHALL MEET THEIR REQUIREMENTS AND SHALL BEAR THEIR LABEL WHEREVER STRADARDS HAVE BEEN ESTABLISHED AND LABEL SERMICE IS REGULARLY FURNISHED BY THAT AGENCY.

6. ELECTRICAL DRAWINGS ARE ESSENTIALLY DIAGRAMMATIC AND ALTHOUGH THE SIZE AND LOCATIONS OF EQUIPMENT ARE SHOWN TO SCALE WHEREVER POSSIBLE, CONTRACTOR SHALL MAKE USE OF ALL DATA IN ALL CONTRACT DOCUMENTS AND VERIFY THIS INFORMATION AT THE SITE. CONTRACTOR SHALL BE RESPONSIBLE FOR LAYING OUT AND INSTALLING HIS WORK TO AVOID INTERFERENCE WITH OTHER TRADES.

CONDUCTORS SHALL BE 600V COPPER CONDUCTORS TYPE THWN UNLESS OTHERWISE NOTED OR REQUIRED BY CODE.

8. WORK SHOWN ON THE DRAWINGS TO BE INSTALLED UNDERGROUND SHALL BE INSTALLED AT LEAST 24" BELOW GRADE. BACKFILL IN 6" THICK, PROPERLY MOISTENED LAYERS, SOLIDLY PACKED AND IRON TAMPED TO A DENSITY NOT LESS THAN THAT OF ADJACENT, UNDISTURBED EARTH. RESTORE SURFACES, ROADWAYS, WALLS, CURBS, WALLS, EXISTING UNDERGROUND INSTALLATIONS TO ORIGINAL CONDITION IN AN ACCEPTABLE MANNER.

9. DETERMINE EXACT ROUTE OF UNDERGROUND CONDUIT WITH LANDSCAPE ARCHITECT IN FIELD PRIOR TO ANY TRENCHING, CONTRACTOR SHALL VERIFY ACTUAL LOCATION OF ALL EXISTING UTILITIES PRIOR TO TRENCHING, ETC.

#### PATHWAY AND PARKING LOT LIGHTING NOTES:

1. ALL WALKWAY LIGHTING AND PARKING LOT LIGHTING SHALL BE UNMETERED, POWERED FROM UTILITY COMPANY POWER SOURCE SUITABLE FOR STREET LIGHTING.

2. ALL POWER SUPPLY TO LUMINAIRES SHALL HAVE APPROPRIATE IN LINE FUSES INSTALLED IN PROPER WEATHERPROOF FUSE HOLDERS LOCATED IN LUMINAIRE HAND HOLES.


4. PROVIDE A 5/8"x8" COPPER CLAD GROUND ROD IN EACH UNDERGROUND PULLBOX FOR PATHWAY LIGHTING SYSTEM. GROUND POLE ASSEMBLY AND GROUND CIRCUIT CONDUCTOR TO THE GROUND ROD USING ∯8 COPPER CONDUCTOR. SEE CITY OF STOCKTON STANDARD DRAWING No. 111.

6. MINIMUM CONDUCTOR SIZE FOR PATHWAY LIGHTING SHALL BE #8 INCLUDING GROUND.

## IRRIGATION CONTROLLER NOTES:

1. LOCATION OF IRRIGATION CONTROLLERS ARE APPROXIMATE ONLY. COORDINATE WITH IRRIGATION SYSTEM CONTRACTOR FOR EXACT LOCATION. PROVIDE HARDWIRED 120Y POWER CONDUIT CONNECTION AT EACH CONTROLLER.

W	IRE	LEGEND				
ID	CONDUIT	WIRE				
A	1.5°C	2#8+1#8 GRD				
В	1.5°C	4#8+1#8 GRD				
С	2°C	3#2+1#8 GRD.(PUMP				
D	1.5"C	PULLROPE				
E	1.5°C	2#8+1#8GRD. (IRRIGATION CONTROLLER)				

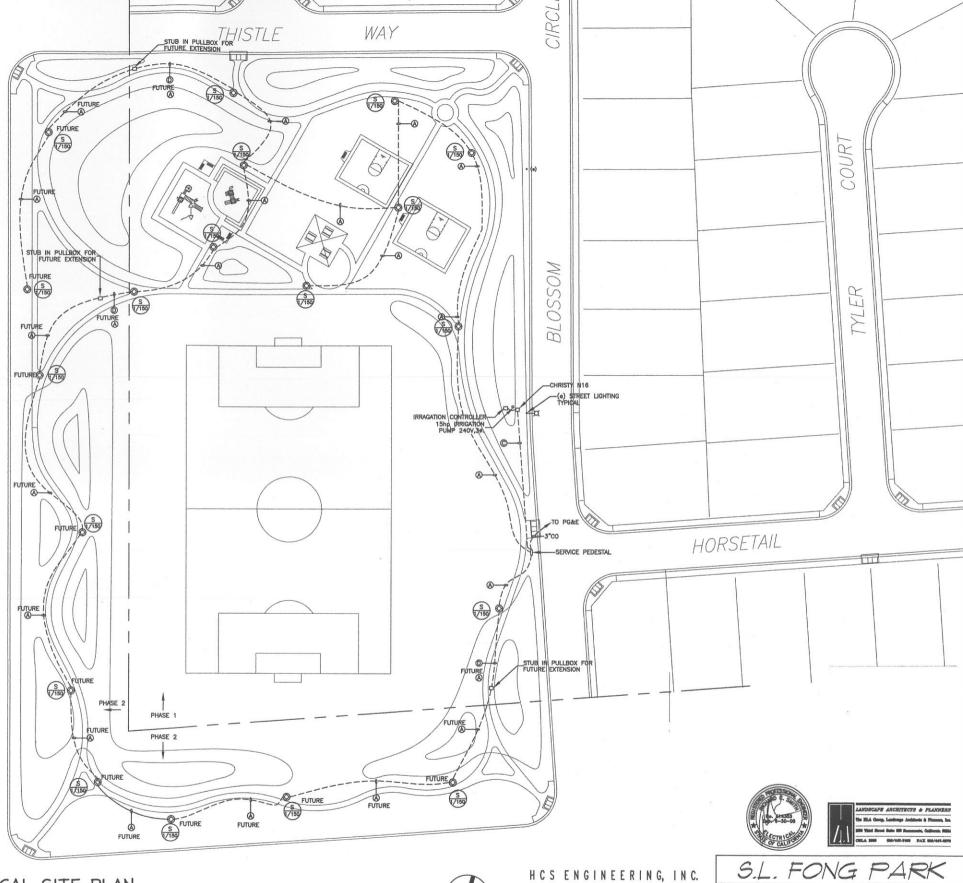

ELECTRICAL SITE PLAN

SCALE | =40'-0"



CONSULTING ELECTRICAL ENGINEERS 4-65-1 QUAIL LAKES DRIVE STOCKTON, CA 95207 (209)478-8270 E-MAIL ADDRESS - resmith@hosengineering.com PROJ.\_\_2001220\_\_DES.\_\_RGS\_\_ENG.\_\_RGS\_\_

SITE LIGHTING PLAN

DEPARTMENT OF PUBLIC WORKS CITY OF STOCKTON, CALIFORNIA


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					CHECKED BY:	RCS	CITY ENGINEER
					RECORD DWG:		STOCKTON, CA.
					DATE:	09-01	DATE: 11/10

DATE: 11/1/02 ILILIT OIN



SHEET NO.

21 OF 24 SHEETS PROJECT NO.

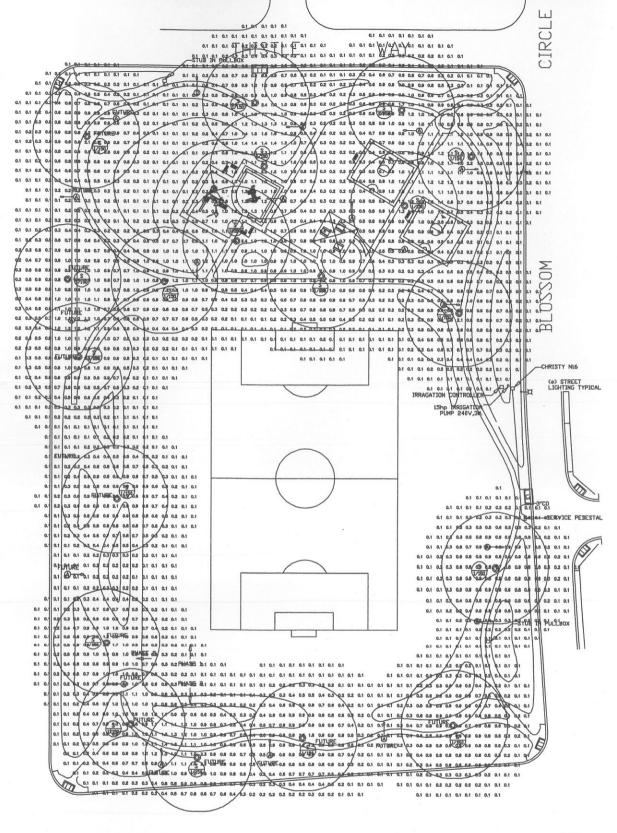

PHOTOMETRIC STUDY







HCS ENGINEERING, INC. CONSULTING ELECTRICAL ENGINEERS

4651 QUAIL LAKES DRIVE STOCKTON, CA 95207 (209)478-8270 E-MAIL ADDRESS - resmith@hesengineering.com
PROJ. 2001.220 DES. RCS ENG. RCS

S.L.	FONG	PARK
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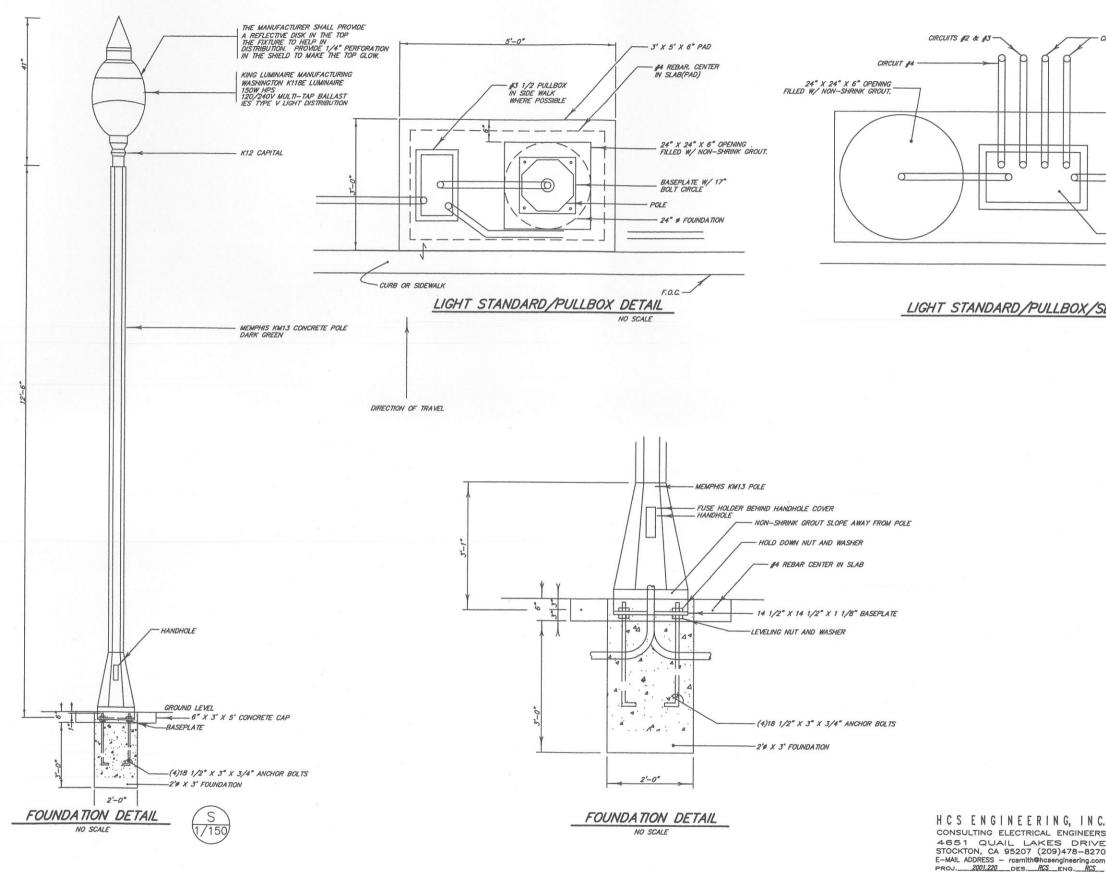
# PHOTOMETRIC STUDY


DEPARTMENT OF PUBLIC WORKS CITY OF STOCKTON, CALIFORNIA

REVISION NO.	DESCRIPTION	DATE	BY	APPRVD. BY	SCALE:	NOTED	APPROVED BY:
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					CHECKED BY:	RCS	
					RECORD DWG:		STOCKTON, CA.,
					DATE	00-01	DATE: 11/1/47.

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SHEET NO. 22 OF 24 SHEETS PROJECT NO.



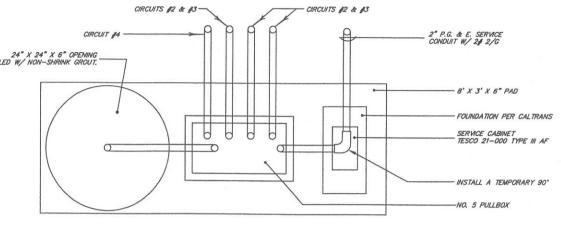

LIGHT STANDARD/PULLBOX/SERVICE DETAIL






S.L. FONG PARK HCS ENGINEERING, INC. CONSULTING ELECTRICAL ENGINEERS 4651 QUAIL LAKES DRIVE STOCKTON, CA 95207 (209)478-8270

ELECTRICAL DETAILS

DEPARTMENT OF PUBLIC WORKS CITY OF STOCKTON, CALIFORNIA

REVISION NO.	DESCRIPTION	DATE	BY	APPRVD. BY	SCALE:	NOTED	APPROVED BY:
1	PLAN CHECK	8/02	RCS		DESIGNED BY:	RCS	
					DRAWN BY:	MEC/RCS	
					CHECKED BY:	RCS	CITY ENGINEER
					RECORD DWG:		CITY ENGINEER STOCKTON, ÇA,
					DATE	00 04	7 1./1/2

SHEET NO.

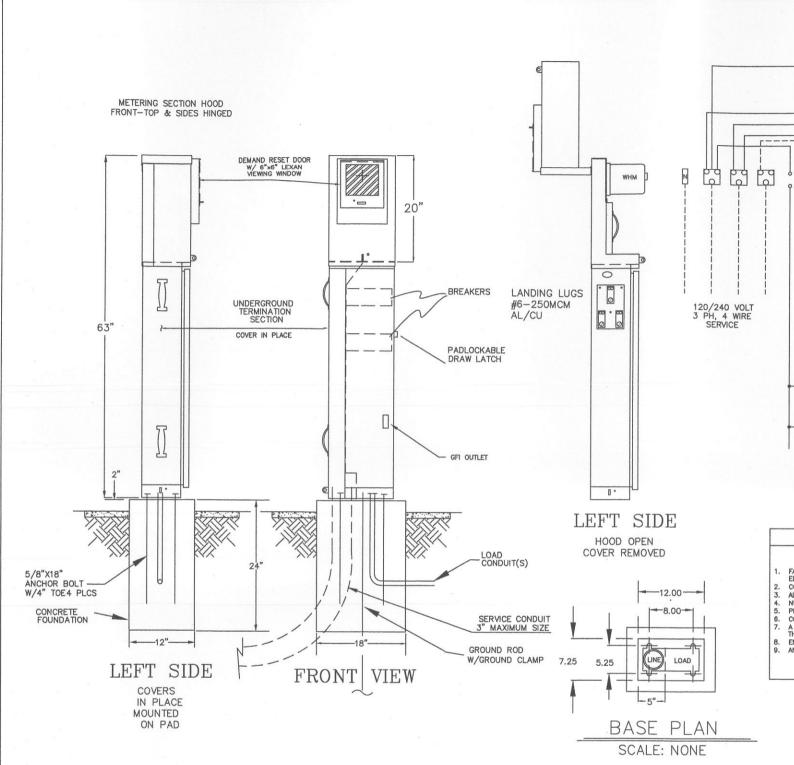



LIGHT SWITCH — SPST UP 48" U.O.N.
120 VOLT DUPLEX WALL OUTLET UP 15" U.O.N.

⇒ 120 VOLT DUPLEX WALL OUTLET UP 15" U.O.N.

⇒ 120 VOLT FOURPLEX OUTLET

□ JUNCTION BOX

→ CONDUIT WITH INSULATED GROUND WIRE

- CONDUIT CONCEALED IN FLOOR OR UNDERGROUND DISTRIBUTION PANEL

LIGHTING PANEL

SIGNAL CABINET AS DESIGNATED

□ PULL BOX

☑ POWER PEDESTAL

③ IRRIGATION CONTROLLER

☐ TRANSFORMER

→ GROUND ELECTRODE

GROUND ELECTRODE PARK LIGHT SEE STANDARD DETAIL SHEET E23

## ELECTRICAL ABBREVIATIONS

A.F.G. ABOVE FINISHED GRADE A.F.F. ABOVE FINISHED FLOOR

UG UNDERGROUND
NL NIGHT LIGHT
WP WEATHERPROOF
CO CONDUIT ONLY

C CONDUIT
U.O.N. UNLESS OTHERWISE NOTED

NO. NUMBER
MIN. MINIMUM
MAX. MAXIMUM

A, AMP AMPERE
W/ WITH
GFI GROUND
& AND

GROUND FAULT INTERRUPTER

**EXISTING** 

REMOVE AMPERE INTERRUPTING CAPACITY

A.I.C. AMPERE I
GRD. GROUND
V VOLT
CKT. CIRCUIT
KW KILOWATT
KVA KILOVOLT
SP SPACE
CU COPPER
AL ALUMINUM
LC LIGHTING
PB PULL BOX

KILOWATT KILOVOLT AMPERE

ALUMINUM LIGHTING CONTACTOR

PULL BOX

# **ENCLOSURE CONSTRUCTION NOTES**

METERING

DIA 422

BLOCKS

MAIN DISCONNECT

RECEPTACLE GFIC

LIGHTING UNMETERED

LIGHTING UNMETERED

TO IRRIGATION CONTROLLER

CONTROL

100/5

80/3

15/1

15/1

30/2

30/2

#8 AWG

GND-

TO 15hp IRRIGATION PUMP

INTERNAL PHOTOCELL

P-WW-0

TEST

AUTO

C1

- FABRICATED FROM 1/8" ALUMINUM SHEET STOCK ELECTRICALLY WELDED AND REINFORCED WHERE REQUIRED. CONSTRUCTION WILL BE NEMA 3R RAINTIGHT ALL NUTS, BOLTS, SOREWS AND HINGES WILL BE STAINLESS STEEL.

WIRING DIAGRAM

- NUTS, BOLTS & SCREWS WILL NOT BE VISIBLE FROM OUTSIDE OF ENCLOSURE.
  PHENOLIC NAMEPLATES WILL BE PROVIDED AS REQUIRED.
  CONTROL WIRING WILL BE MARKED AT BOTH ENDS BY PERMANENT WIRE MARKERS.
- A PLASTIC COVERED WIRING DIAGRAM WILL BE ATTACHED TO THE INSIDE OF THE FRONT DOOR.
- INC. FROM DOUR.

  ENCLOSURE WILL BE FACTORY WIRED AND CONFORM TO REQUIRED NEMA STANDARDS.

  ANODIZED AFTER FABRICATION
- MINIMUM DIMENSIONS INDICATED, PEDESTAL ENCLOSURE TO BE SIZED PER P.G.&E. REQUIREMENTS AND TO INCORPORATE ALL ITEMS PER ONE LINE DIAGRAM AND CONTROL SCHEMATICS.
- PEDESTAL AS MANUFACTURED BY TESCO OR MILBANK WEST, WITH A METERED SECTION, CIRCUIT BREAKER DISTRIBUTION SECTION, CONTACTORS, RECEPTACLES, PHOTOCELL, TERMINAL BLOCKS, SEPARATION BARRIERS, ETC. MADE OF ANODIZED ALUMINUM ALL FASTENERS & HINGES TO BE STAINLESS STEEL.
- COMPLETE PEDESTAL SHALL COMPLY WITH UTILITY REGULATIONS AND REQUIREMENTS AND SHALL BE APPROVED BY THE SAME PRIOR TO FABRICATION.
- 13. FINISH COLOR: ANODIZED ALUMINUM. NO PAINTING IS ALLOWED.
- 14. UL LISTED.






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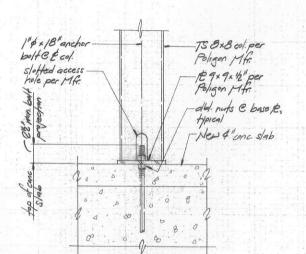
# PEDESTAL DETAILS

DEPARTMENT OF PUBLIC WORKS CITY OF STOCKTON, CALIFORNIA


NO.	DESCRIPTION	DATE	BY	APPRVD.	SCALE:	NOTED	APPROVED I
1	PLAN CHECK	8/02	RCS		DESIGNED BY:		
					DRAWN BY:	MEC/RCS	J. Lula
					CHECKED BY:	RCS	CITY ENGINE
					RECORD DWG:		CITY ENGINE
		State of Participation	Sec. (1997)		DATE.	00 01	0.4=== 1

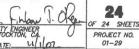


SHEET NO.





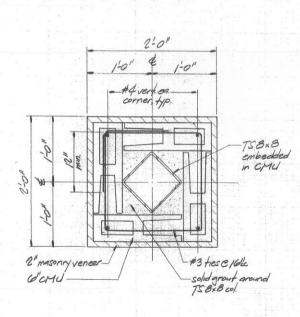



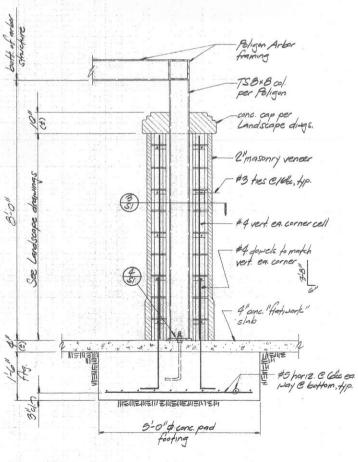

DETAIL 3/4" = 1'- 0" S/

# **General Notes**

Applicable Codes
All details of design and construction shall comply with the Uniform Building Code, 1997 Edition.

All details or uses an action of the Control of the

- Seismic. Zone 3, Sp. soil profile

  Foundations

  1. Notify Engineer 48 hours before pouring foundations for inspection.

  2. Soils information. No soils report available. Assumed max. allowable soil values per UBC Table 18-I-A:

   Fap = 1,000 per (Dt+LL).

   Passive pressure = 100 psr per foot of depth.

  3. Foolings shall be are on firm, undisturbed ristural-ground. All bearing foundations shall be poured into neat excavations, and precautions taken to prevent the edges from sloughing into the excavations. Bottoms of foolings shall be leave.

  4. Bearing surfaces of columns on footings shall be are shooth and level; all bearing surfaces shall be are uniform elevation. Maintain minimum projection of anchor bolt above finished slab surface of 2-1/2 inches per details.

  Concrete

- Inches per details.

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  Reinforcing steel shall be intermediate grade billet steel bars conforming to ASTM designation A-615, Grade 60. All clear dimensions shown for location of reinforcing are to face of bars and denote clear coverage.

  All dimensions shown for location of reinforcing are to face of main bars and denote clear coverage.


  Concrete coverage shall be as shown on the details.

  Concrete mix shall be proportioned such that all structural concrete has an ultimate compressive strength (°C) of 2,500 psi minimum at 28 days. Concrete mix design shall be prepared by a qualified laboratory and submitted to the Structural Engineer for review and approval prior to any placement of concrete. No special inspection of concrete work is required.

  Miscollaneous

  Design and fabrication of the Poligon arbor structure above finished slab elevation shall be the responsibility of the manufacturer, refer to manufacturer's drawings for dimensions, member sizes, connections, etc.

  Refer to Landscape drawings by The HLA Group for details of concrete slab "flatvork", i.e., slab elevations and/or aloges, slab thickness, reinforcement, underlayment, and joint types / locations at area of Poligon arbor and trelits structures.

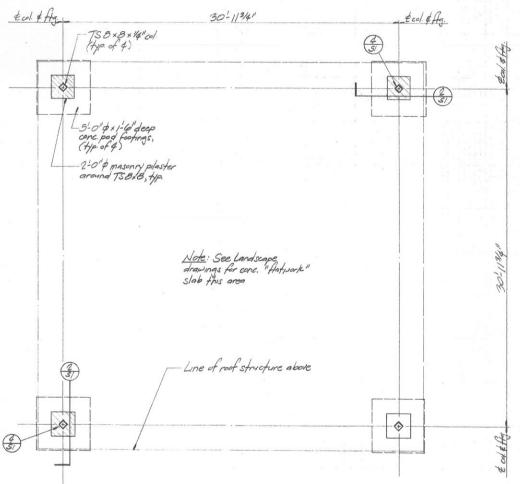

**POLIGON ARBOR MODEL SQ 36 TG FOUNDATION PLAN** 

Crawford & Associates

Consulting Structural Engineers 4401 Hazel Avenue, Suite 250 Fair Oaks, California 95628 Phone: (916) 967-4510 Fax: (916) 967-4917

SL FONG PARK

FOUNDATION PLAN

DATE: 1/102

DEPARTMENT OF PUBLIC WORKS CITY OF STOCKTON, CALIFORNIA


SCALE: AS SHOWN DESCRIPTION G Finder J. Okey DESIGNED BY MDC DRAWN BY: MDC CHECKED BY: MDC STOCKTON, CA

DATE: AUGUST 16, 2002

**S1** 

OF 24 SHEETS

PROJECT NO.

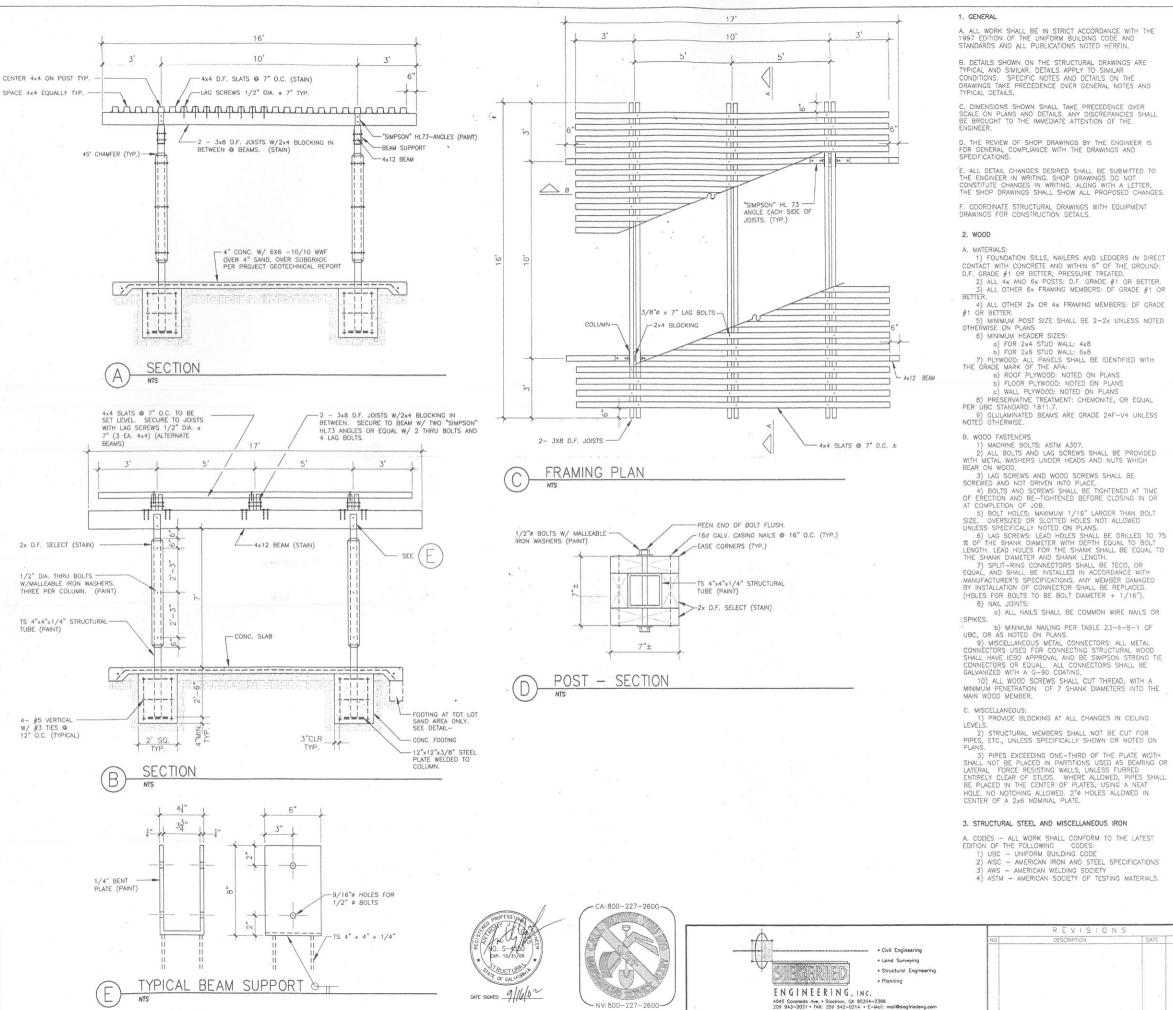

A. ALL WORK SHALL BE IN STRICT ACCORDANCE WITH THE 1997 EDITION OF THE UNIFORM BUILDING CODE AN STANDARDS AND ALL PUBLICATIONS NOTED HEREIN.

B. DETAILS SHOWN ON THE STRUCTURAL DRAWINGS ARE TYPICAL AND SIMILAR, DETAILS APPLY TO SIMILAR CONDITIONS. SPECIFIC NOTES AND DETAILS ON THE DRAWINGS TAKE PRECEDENCE OVER GENERAL NOTES AND TYPICAL DETAILS.

C. DIMENSIONS SHOWN SHALL TAKE PRECEDENCE OVER SCALE ON PLANS AND DETAILS. ANY DISCREPANCIES SHALL BE BROUGHT TO THE IMMEDIATE AITENTION OF THE

D. THE REVIEW OF SHOP DRAWINGS BY THE ENGINEER IS FOR GENERAL COMPLIANCE WITH THE DRAWINGS AND

E. ALL DETAIL CHANGES DESIRED SHALL BE SUBMITTED TO THE ENGINEER IN WRITING, SHOP DRAWINGS DO NOT CONSTITUTE CHANGES IN WRITING, ALONG WITH A LETTER, THE SHOP DRAWINGS SHALL SHOW ALL PROPOSED CHANGE:

F. COORDINATE STRUCTURAL DRAWINGS WITH EQUIPMENT DRAWINGS FOR CONSTRUCTION DETAILS.

1) FOUNDATION SILLS, NAILERS AND LEDGERS IN DIRECT CONTACT WITH CONCRETE AND WITHIN 6" OF THE GROUND:
D.F. GRADE #1 OR BETTER, PRESSURE TREATED.
2) ALL 4x AND 6x POSTS: D.F. GRADE #1 OR BETTER.
3) ALL OTHER 6x FRAMING MEMBERS: DF GRADE #1 OR

4) ALL OTHER 2x OR 4x FRAMING MEMBERS: DF GRADE

5) MINIMUM POST SIZE SHALL BE 2-2x UNLESS NOTED OTHERWISE ON PLANS

6) MINIMUM HEADER SIZES:

a) FOR 2x4 STUD WALL: 4x8
b) FOR 2x6 STUD WALL: 6x8
7) PLYWOOD: ALL PANELS SHALL BE IDENTIFIED WITH THE GRADE MARK OF THE APA:

ade mark of the APA:

a) ROOF PLYWOOD: NOTED ON PLANS
b) FLOOR PLYWOOD: NOTED ON PLANS
c) WALL PLYWOOD: NOTED ON PLANS

B) PRESERVATIVE TREATMENT: CHEMONITE, OR EQUAL PER UBC STANDARD 1811.7.

9) GLULAMINATED BEAMS ARE GRADE 24F-V4 UNLESS NOTED OTHERWISE.

1) MACHINE BOLTS: ASTM A307.
 2) ALL BOLTS AND LAG SCREWS SHALL BE PROVIDED WITH METAL WASHERS UNDER HEADS AND NUTS WHICH BEAR ON WOOD.

THE SHANK DIAMETER AND SHANK LENGTH:

7) SPLIT-RING CONNECTORS SHALL BE TECO, OR
EQUAL, AND SHALL BE INSTALLED IN ACCORDANCE WITH
MANUFACTURER'S SPECIFICATIONS, ANY MEMBER DAMAGED
BY INSTALLATION OF CONNECTOR SHALL BE REPLACED.

(HOLES FOR BOLITS TO BE BOLT DIAMETER + 1/16").

a) ALL NAILS SHALL BE COMMON WIRE NAILS OR

"SPIKES."

b) MINIMUM NAILING PER TABLE 23—II—B—1 OF UBC, OR AS NOTED ON PLANS.

9) MISCELLARAGOUS METAL CONNECTORS: ALL METAL CONNECTORS USED FOR CONNECTING STRUCTURAL WOOD SHALL HAVE ICBO APPROVAL AND BE SIMPSON STRONG TIE CONNECTORS OR EQUAL. ALL CONNECTORS OR EQUAL. ALL CONNECTORS SHALL BE GALVANIZED WITH A G—90 COATING.

10) ALL WOOD SCREWS SHALL CUT THREAD, WITH A MINIMUM PENETRATION OF 7 SHANK DIAMETERS INTO THE MAIN WOOD MEMBER.

1) PROVIDE BLOCKING AT ALL CHANGES IN CEILING LEVELS.

2) STRUCTURAL MEMBERS SHALL NOT BE CUT FOR PIPES, ETC., UNLESS SPECIFICALLY SHOWN OR NOTED ON PLANS.

PLANS.

3) PIPES EXCEEDING ONE—THIRD OF THE PLATE WIDTH SHALL NOT BE PLACED IN PARTITIONS USED AS BEARING OR LATERAL FORCE RESISTING WALLS, UNLESS FURRED ENTIRELY CLEAR OF STUDS. WHERE ALLOWED, PIPES SHALL BE PLACED IN THE CENTER OF PLATES, USING A NEAT HOLE, NO NOTCHING ALLOWED, 2" HOLES ALLOWED IN CENTER OF A 2x6 NOMINAL PLATE.

## 3. STRUCTURAL STEEL AND MISCELLANEOUS IRON

A. CODES - ALL WORK SHALL CONFORM TO THE LATEST EDITION OF THE FOLLOWING CODES:

1) UBC - UNIFORM BUILDING CODE
 2) AISC - AMERICAN IRON AND STEEL SPECIFICATIONS

3) AWS - AMERICAN WELDING SOCIETY 4) ASTM - AMERICAN SOCIETY OF TESTING MATERIALS.

- 1) STRUCTURAL STEEL MEMBERS: ASTM A-36 OR PER PLAN.
- 2) STRUCTURAL TUBING: ASTM A500 GRADE B.
- 3) STRUCTURAL PIPES: ASTM ASS GRADE B.
  4) NUTS, BOLTS, WASHERS: ASTM A307, UNLESS OTHERWISE NOTED ON PLANS.
- 5) HIGH-STRENGTH NUTS, BOLTS, WASHERS: ASTM A325. 6) WELDING MATERIAL: E-70 ELECTRODES PER AWS-01-1.
- AWS-01-1.

  7) PAINT PRIMER: FED. SPEC. TT-D31, RED OXIDE.

  8) GALVANIZING: ASTM A575 MIN. 207 HOT-DIPPED.

  9) STEEL STUD MATERIAL: SHALL CONFORM TO ASTM
  A+466-91 GRADE A, ADD/OR UBC T20-11, WITH A
  MINIMUM YIELD STRENGTH OF 33 KSI.

#### C. FABRICATION:

... ABBIGATION:

1) WELDING: WELDING SHALL BE PERFORMED BY CERTIFIED WELDERS ONLY IN AN ICBO APPROVED WELD SHOP.

SHOP.

2) SHOP FABRICATION TO THE GREATER POSSIBLE EXTENT.

3) SHOP PRIME ALL STEEL EXCEPT GALVANIZED STEEL. DO NOT PRIME SURFACES TO BE WELDED OR WHICH WILL BE PLACED INTO CONCRETE.

4) BOLT HOLES TO BE DRILLED MAXIMUM 1/16" LARGER THAN BOLT DIAMETER UNLESS OTHERWISE NOTED ON PLANS.

#### D. SHOP DRAWINGS:

SHOP DRAWINGS SHALL BE SUBMITTED FOR ALL STRUCTURAL STEEL MEMBERS.
 COORDINATE SHOP DRAWINGS WITH ALL TRADES.

E. TESTING AND INSPECTION:

1) STRUCTURAL STEEL: SUBMIT MILL REPORTS AS PER AISC SPECIFICATIONS.

2) HIGH-STRENGTH NUTS, BOLTS AND WASHERS: PROVIDE WRITTEN MILL CERTIFICATES.

PROVIDE WRITTEN MILL CERTIFICATES.

3) ALL FIELD WELDING SHALL BE BY A CERTIFIED WELDER AND INSPECTED BY AN APPROVED WELDING INSPECTOR.

4) HIGH-STRENGTH BOLTS SHALL BE INSPECTED BY A QUALIFIED INSPECTOR APPROVED BY THE ENGINEER.

#### 4. CONCRETE

B. CONCRETE STRENGTH: CONCRETE SHALL OBTAIN A MINIMUM DESIGN STRENGTH OF DESIGN STRENGTH OF

9) SLAB: 3,000 PSI;

1) CEMENT: 5.5 SACK PER YARD FOR 3,000 PSI CONCRETE.

2) WATER: MAXIMUM 7 GALLONS PER SACK OF CEMENT.

3) AGGREGATE: MAXIMUM SIZE 3/4"

4) SLUMP: 4" MAXIMUM M.

5) CURING: KEEP WET MINIMUM OF 7 DAYS OR APPLY MEMBRANE CURING COMPOUND APPROVED BY THE ENGINEER.

6) VIBRATION: ALL CONCRETE SHALL BE VIBRATED INTO PLACE WITH A MECHANICAL VIBRATOR.

7) FORM REMOVAL SIDE FORMS OF FOUNDATIONS AND SLABS AFTER A MINIMUM OF 2 DAYS.

8) TESTING: IN ACCORDANCE WITH ACI-318-99, CH. 3.

C. REINFORCING MATERIALS:

DEFORMED BARS: ASTM AG15 GRADE 60, UNLESS OTHERWISE NOTED.

2) ELECTRIC WELDED WIRE FABRIC (WWF): ASTM A-185.
3) MINIMUM LAP SPLICES AS FOLLOWS UNLESS OTHERWISE NOTED:#3-#4=24", #5=30", #6=38", #7-55", #8-72",

#9-92"

4) FOR SLABS ON GROUND, REINFORCING BARS SHALL BE HELD IN PLACE AT THE CENTERLINE OF THE SLAB BY MEANS OF CONCRETE BLOCKS, BAR CHAINS OR OTHER APPROVED METHOD. BARS SHALL NOT BE POSITIONED BY PULLING UP WITH HOOKS AS CONCRETE IS POURED.

MISCEL BANFOLIS.

WITH HOOKS AS CONCRETE IS POURED.

O. MISCELANEOUS:

1) PROVIDE 3/4" CHAMFER ON ALL EXPOSED CONCRETE.
EDGES UNLESS OTHERWISE NOTED ON PLANS.

2) ANCHOR BOLTS AND DOWELS MUST BE SECURELY
SUPPORTED IN PLACE BEFORE POURING CONCRETE TO INSURE
PROPER LOCATION PER PLAN.

## 5. SITE NOTES

A. PROVIDE FINE HAIR BROOM FINISH ON ALL CONCRETE

B. CONSTRUCTION SHALL BE IN ACCORDANCE WITH THE CITY APPLICABLE SECTIONS OF THE CURRENT CITY OF STOCKTON B. CONSTRUCTION SHALL BE IN ALCORDANCE WITH THE CLAPPLICABLE SECTIONS OF THE CURRENT CITY OF STOCKTO STANDARD SPECIFICATIONS.

C. SUBGRADE UNDER SAND BASE SHALL BE COMPACTED TO 90% RELATIVE COMPACTION. D. WEAKENED PLANE JOINTS SHALL BE 1½" DEEP @ 10'-0" O.C.

# 6 PAINTING

A. METALS SHALL BE PAINTED

1 COAT RUST INHIBITIVE PRIMER

2 COATS EXTERIOR ENAMEL (VELVACON MAHOGANY Q2—694)

B. WOOD SHALL BE STAINED

B. WOUD SHALL BE STAINED
2 COATS OLYMPIC HEAVY BODY (MAHOGANY) STAIN SHALL BE
APPLIED BY BRUSH FOR FIRST COAT.
C. CONTRACTOR SHALL SUBMIT COLOR SAMPLES TO THE CITY
OF STOCKTON PARKS AND RECREATION DEPARTMENT FOR

## S. L. FONG PARK PHASE 1

# SHADE STRUCTURE

## DEPARTMENT OF PUBLIC WORKS CITY OF STOCKTON, CALIFORNIA

SHEET NO. 11/02 S-1 OF 1 SHEETS

DRAWN BY: Enbar J.Oken CHECKED BY: F. B. NO.: C.O.S. JOB NO.